
TOWN OF DEERFIELD, MASSACHUSETTS KELLEHER DRIVE CULVERT REPLACEMENT PROJECT


BID SET - APRIL 2020 RECORD DRAWINGS - JULY 2021


LIST OF DRAWINGS			
SHEET NO.	SHEET TITLE		
G-001	COVER		
G-002	LEGEND, ABBREVIATIONS AND GENERAL NOTES		
C-101	EXISTING CONDITIONS SITE PLAN		
C-102	PROPOSED CONDITIONS SITE PLAN		
C-103	PROPOSED CONDITIONS PROFILE		
C-104	CONSTRUCTION DETAILS		
C-105	WETLAND RESTORATION DETAILS		
C-106	GUARDRAIL DETAILS		
C-107	TEMPORARY TRAFFIC CONTROL		

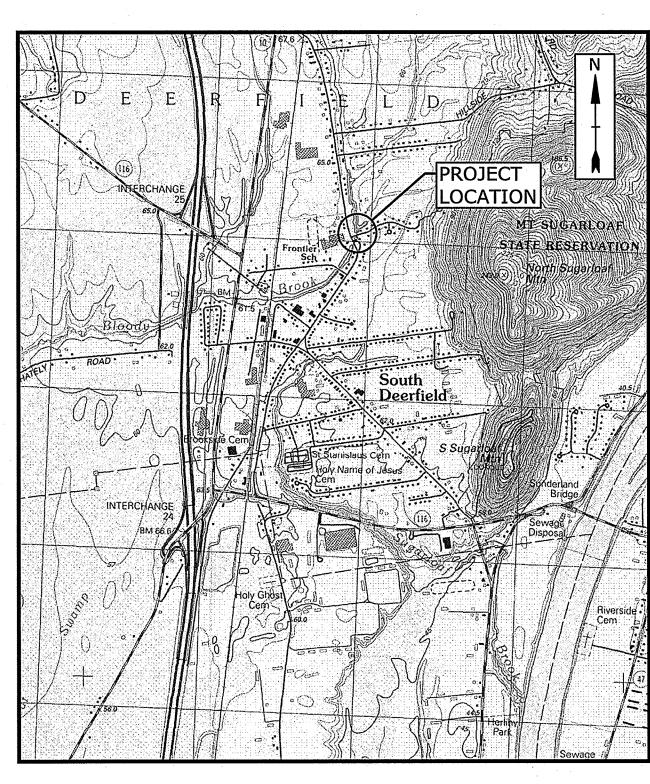

LOCATION MAP
SCALE: 1"=2000"



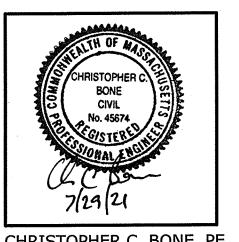

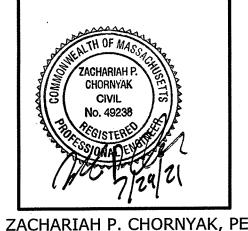

TOPHER C. BONE, PE ZACHARIAH P. CHORNY

PREPARED FOR:

TOWN OF DEERFIELD

KAYCE WARREN, TOWN ADMINISTRATOR

KEVIN SCARBOROUGH, DPW SUPERINTENDENT

RECORD DRAWING

THIS RECORD DRAWING WAS PREPARED BASED ON AS-BUILT INFORMATION PROVIDED BY THE CONTRACTOR AND INDICATES ONLY SIGNIFICANT CHANGES MADE FROM THE DESIGN DRAWINGS DURING CONSTRUCTION.

COMPLETE SET 9 SHEETS

GENERAL NOTES

- 1. BASE PLAN PREPARED BY NORTHEAST SURVEY CONSULTANTS, INC. ON DECEMBER 19, 2019. EXISTING PROPERTY LINES ARE BASED ON AN ASSESSORS PLAN, AND ARE APPROXIMATE AND FOR ORIENTATION PURPOSES ONLY.
- 2. THE HORIZONTAL DATUM IS BASED ON THE NORTH AMERICAN DATUM OF 1983 (NAD83). THE VERTICAL DATUM IS BASED ON THE NORTH AMERICAN VERTICAL DATUM OF 1988 (NAVD88). BOTH WERE DERIVED FROM RTK GPS OBSERVATIONS
- 3. BOLD TEXT AND LINES INDICATE PROPOSED WORK. LIGHT TEXT AND LINES INDICATE APPROXIMATE EXISTING CONDITIONS.
- 4. WETLAND RESOURCE AREAS WERE DELINEATED BY TIGHE & BOND ON 11/21/2019.
- 5. SOIL BORINGS WERE ADVANCED BY SEABOARD DRILLING, INC. ON 11/29/2019.
- 6. NOTIFY "DIGSAFE" AT 1-888-344-7233 TO ARRANGE FOR MARKING OUT EXISTING UNDERGROUND UTILITIES AT LEAST 72 HOURS (EXCLUDING SATURDAYS, SUNDAYS, AND HOLIDAYS) PRIOR TO BEGINNING EXCAVATION AT ANY GIVEN LOCATION. UNDER NO CIRCUMSTANCES SHALL THE CONTRACTOR BE ALLOWED TO START ANY KIND OF EXCAVATION WORK PRIOR TO OBTAINING ALL THE NECESSARY INFORMATION REGARDING THE LOCATION OF UNDERGROUND UTILITIES AT THE SITE. ACCOMPLISH ALL EXCAVATION SO THAT UNDERGROUND UTILITIES OR STRUCTURES ARE NOT DAMAGED. CONTRACTOR SHALL BE RESPONSIBLE FOR ANY DAMAGE INCURRED DURING EXCAVATION OPERATIONS. REPAIR ANY EXISTING PIPE OR UTILITY DAMAGED DURING CONSTRUCTION AT NO ADDITIONAL COST TO THE OWNER.
- 7. THE OWNER AND ENGINEER ASSUME NO RESPONSIBILITY FOR THE LOCATION OF EXISTING UTILITIES. THE ENGINEER AND OWNER MAKE NO GUARANTEE AS TO THE UNDERGROUND CONDITIONS THAT MAY BE ENCOUNTERED.
- 8. FIELD MEASURE TO VERIFY EXISTING AND CONTRACT INTERFACE DIMENSIONS, LOCATIONS, AND OTHER CONDITIONS.
- 9. TEST PITS TO LOCATE EXISTING UTILITIES ARE STRONGLY ENCOURAGED AND MAY BE ORDERED BY THE ENGINEER.
- 10. IF CHANGES TO THE DESIGN ARE PROPOSED, THE PROPOSED CHANGES SHALL BE SUBMITTED TO THE OWNER/ENGINEER FOR REVIEW AND APPROVAL PRIOR TO CONSTRUCTION (MAY REQUIRE PERMIT MODIFICATIONS OR NEW FORMAT(S).
- 11. NO OPEN TRENCHES WILL BE ALLOWED OVERNIGHT. THE USE OF ROAD PLATES TO PROTECT THE EXCAVATION WILL BE CONSIDERED UPON REQUEST, BUT BACKFILLING IS PREFERRED.
- 12. STORE FUEL, OIL, PAINT, OR OTHER HAZARDOUS MATERIALS IN A SECONDARY CONTAINER AND REMOVE FROM THE SITE TO A LOCKED INDOOR AREA WITH AN IMPERVIOUS FLOOR DURING NON-WORK HOURS.
- 13. IMMEDIATELY REPORT SPILLS OF OIL AND/OR HAZARDOUS MATERIALS (OHM) TO THE MASSDEP.
- 14. PROVIDE A SUFFICIENT SUPPLY OF ABSORBENT SPILL RESPONSE MATERIALS, SUCH AS BOOMS OR BLANKETS, AT THE CONSTRUCTION SITE AT ALL TIMES TO CLEAN UP POTENTIAL SPILLS OF HAZARDOUS MATERIALS.
- 15. FURNISH AND INSTALL TRAFFIC CONTROL/SAFETY DEVICES TO ENSURE SAFE VEHICULAR TRAFFIC THROUGH THE WORK AREA OR FOR SAFELY IMPLEMENTING DETOURS AROUND THE WORK AREA.
- 16. MAKE NECESSARY ARRANGEMENTS TO PERFORM ANY WORK NEAR THE OVERHEAD UTILITIES PRIOR TO THE START OF CONSTRUCTION.

SURFACE RESTORATION NOTES

- 1. RESTORE ALL AREAS DISTURBED BY THE CONTRACTOR BEYOND THE LIMITS OF WORK TO ORIGINAL CONDITIONS AT NO ADDITIONAL COST TO THE OWNER.
- 2. ALL PAVEMENT DAMAGED BY THE CONTRACTOR'S OPERATIONS SHALL BE REPLACED IN ACCORDANCE WITH THE CONTRACT DOCUMENTS.
- 3. PROTECT SURFACE FEATURES (E.G., WALLS, FENCES, MAIL BOXES, SIGNS, SIDEWALKS, CURBING, STAIRS, WALKWAYS, TREES, ETC.) FROM DAMAGE DURING CONSTRUCTION, INCLUDING PROVIDING TEMPORARY SUPPORTS, WHEN
- 4. IF REMOVAL OF SURFACE FEATURES IS REQUIRED IN ORDER TO PERFORM THE PROPOSED WORK, REMOVE THOSE SITE FEATURES ONLY UPON APPROVAL OF ENGINEER. REPLACE ALL REMOVED SITE FEATURES; NEW ITEMS SHALL BE EQUAL OR BETTER IN QUALITY AND CONDITION TO THE ITEMS REMOVED.
- 5. EXISTING SURVEY MONUMENTS DISTURBED BY THE CONTRACTOR SHALL BE REPLACED BY A LAND SURVEYOR LICENSED IN MASSACHUSETTS AT NO ADDITIONAL COST TO THE OWNER.
- 6. REPAIR DISTURBED PAVED SURFACES AT THE END OF EACH WORK WEEK, UNLESS OTHERWISE APPROVED/REQUIRED BY THE OWNER.


LEGEND


	EXISTING	NEW	
_			EDGE OF PAVEMENT
-	· · · · · · · · · · · · · · · · · · ·		GRAVEL DRIVE
_	- 		FENCE
_	SD		STORM DRAIN
_	OE		OVERHEAD ELECTRIC
_			APPROXIMATE PROPERTY LINE
	0 0 0		GUARDRAIL
		490	INDEX CONTOUR
	NAME AND ADDRESS ASSESSED ASSE		INTERMEDIATE CONTOUR
-			THALWEG
	<u> </u>		CONTROL POINT
	₿ 1		BORING
	345.4	351.3	PROFILE ELEVATIONS
	•1A-1		WETLAND FLAGS
			WETLAND SYMBOL
	•		GUY WIRE
			SIGN
	<u>م</u> ۵	_	DOUBLE POLE SIGN
	•		PIPE OUTLET
	₩		
		·	MANHOLE
	⋄		HYDRANT
	29		WATER VALVE
			CATCH BASIN
	•		DRAIN MANHOLE
	•		TELEPHONE MANHOLE
	D		UTILITY POLE
			TEMPORARY COFFER DAM
•			EROSION CONTROL BARRIERS
_	<u> </u>		BORDERING VEGETATED WETLANDS
_		·	SURVEYED EDGE OF WATER (DECEMBER 2019)
_			TOP OF BANK/MEAN ANNUAL HIGH WATER (MAHW)
			100-FOOT BUFFER ZONE
36			200-FOOT RIVERFRONT AREA
			LAND SUBJECT TO FLOODING
•	•		TEMPORARY BENCH MARK
	240 m		DECIDUOUS TREE
		* * *	CONIFEROUS TREE
			WETLAND MITIGATION AREA

ABBREVIATIONS

	APPROX	APPROXIMATE
	BIT	BITUMINOUS
	BVW	BORDERING VEGETATIVE WETLANDS
	CFS	CUBIC FEET PER SECOND
	CONC	CONCRETE
	CMP	CORRUGATED METAL PIPE
	D	DIAMETER
	DPW	DEPARTMENT OF PUBLIC WORKS
	EL/ELEV	ELEVATION
	EXIST	EXISTING
	FIN	FINISHED
	1	FEET/FOOT
	11	INCH
	± .	PLUS/MINUS
	HDPE	HIGH DENSITY POLYETHYLENE
	Н	HEIGHT
	НМА	HOT MIX ASPHALT
	INV	INVERT ELEVATION
. **	IP	IRON PIN
	L	LENGTH
	LF	LINEAR FEET
	MASSDEP	MASSACHUSETTS DEPARTMENT OF ENVIRONMENTAL PROTECTION
	MAX	MAXIMUM
	MIN	MINIMUM
	MISC	MISCELLANEOUS
	N/F	NOW/FORMERLY
	PROP	PROPOSED
	SF	SQUARE FEET
	STA	SURVEY STATION
	Т	TOP
	ТВМ	TEMPORARY BENCH MARK
	TYP	TYPICAL
	UP	UTILITY POLE
	W	WIDTH



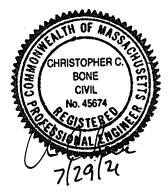

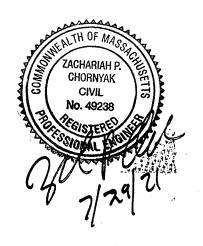

Town of Deerfield

Kelleher Drive Culvert Replacement Project

Deerfield, Massachusetts

	7/28/2021	RECORD DRAWING
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LE:	2	5017-005-G-002.dwg

LEGEND, ABBREVIATIONS AND GENERAL NOTES

TMP

ABM

PMV, ZPC

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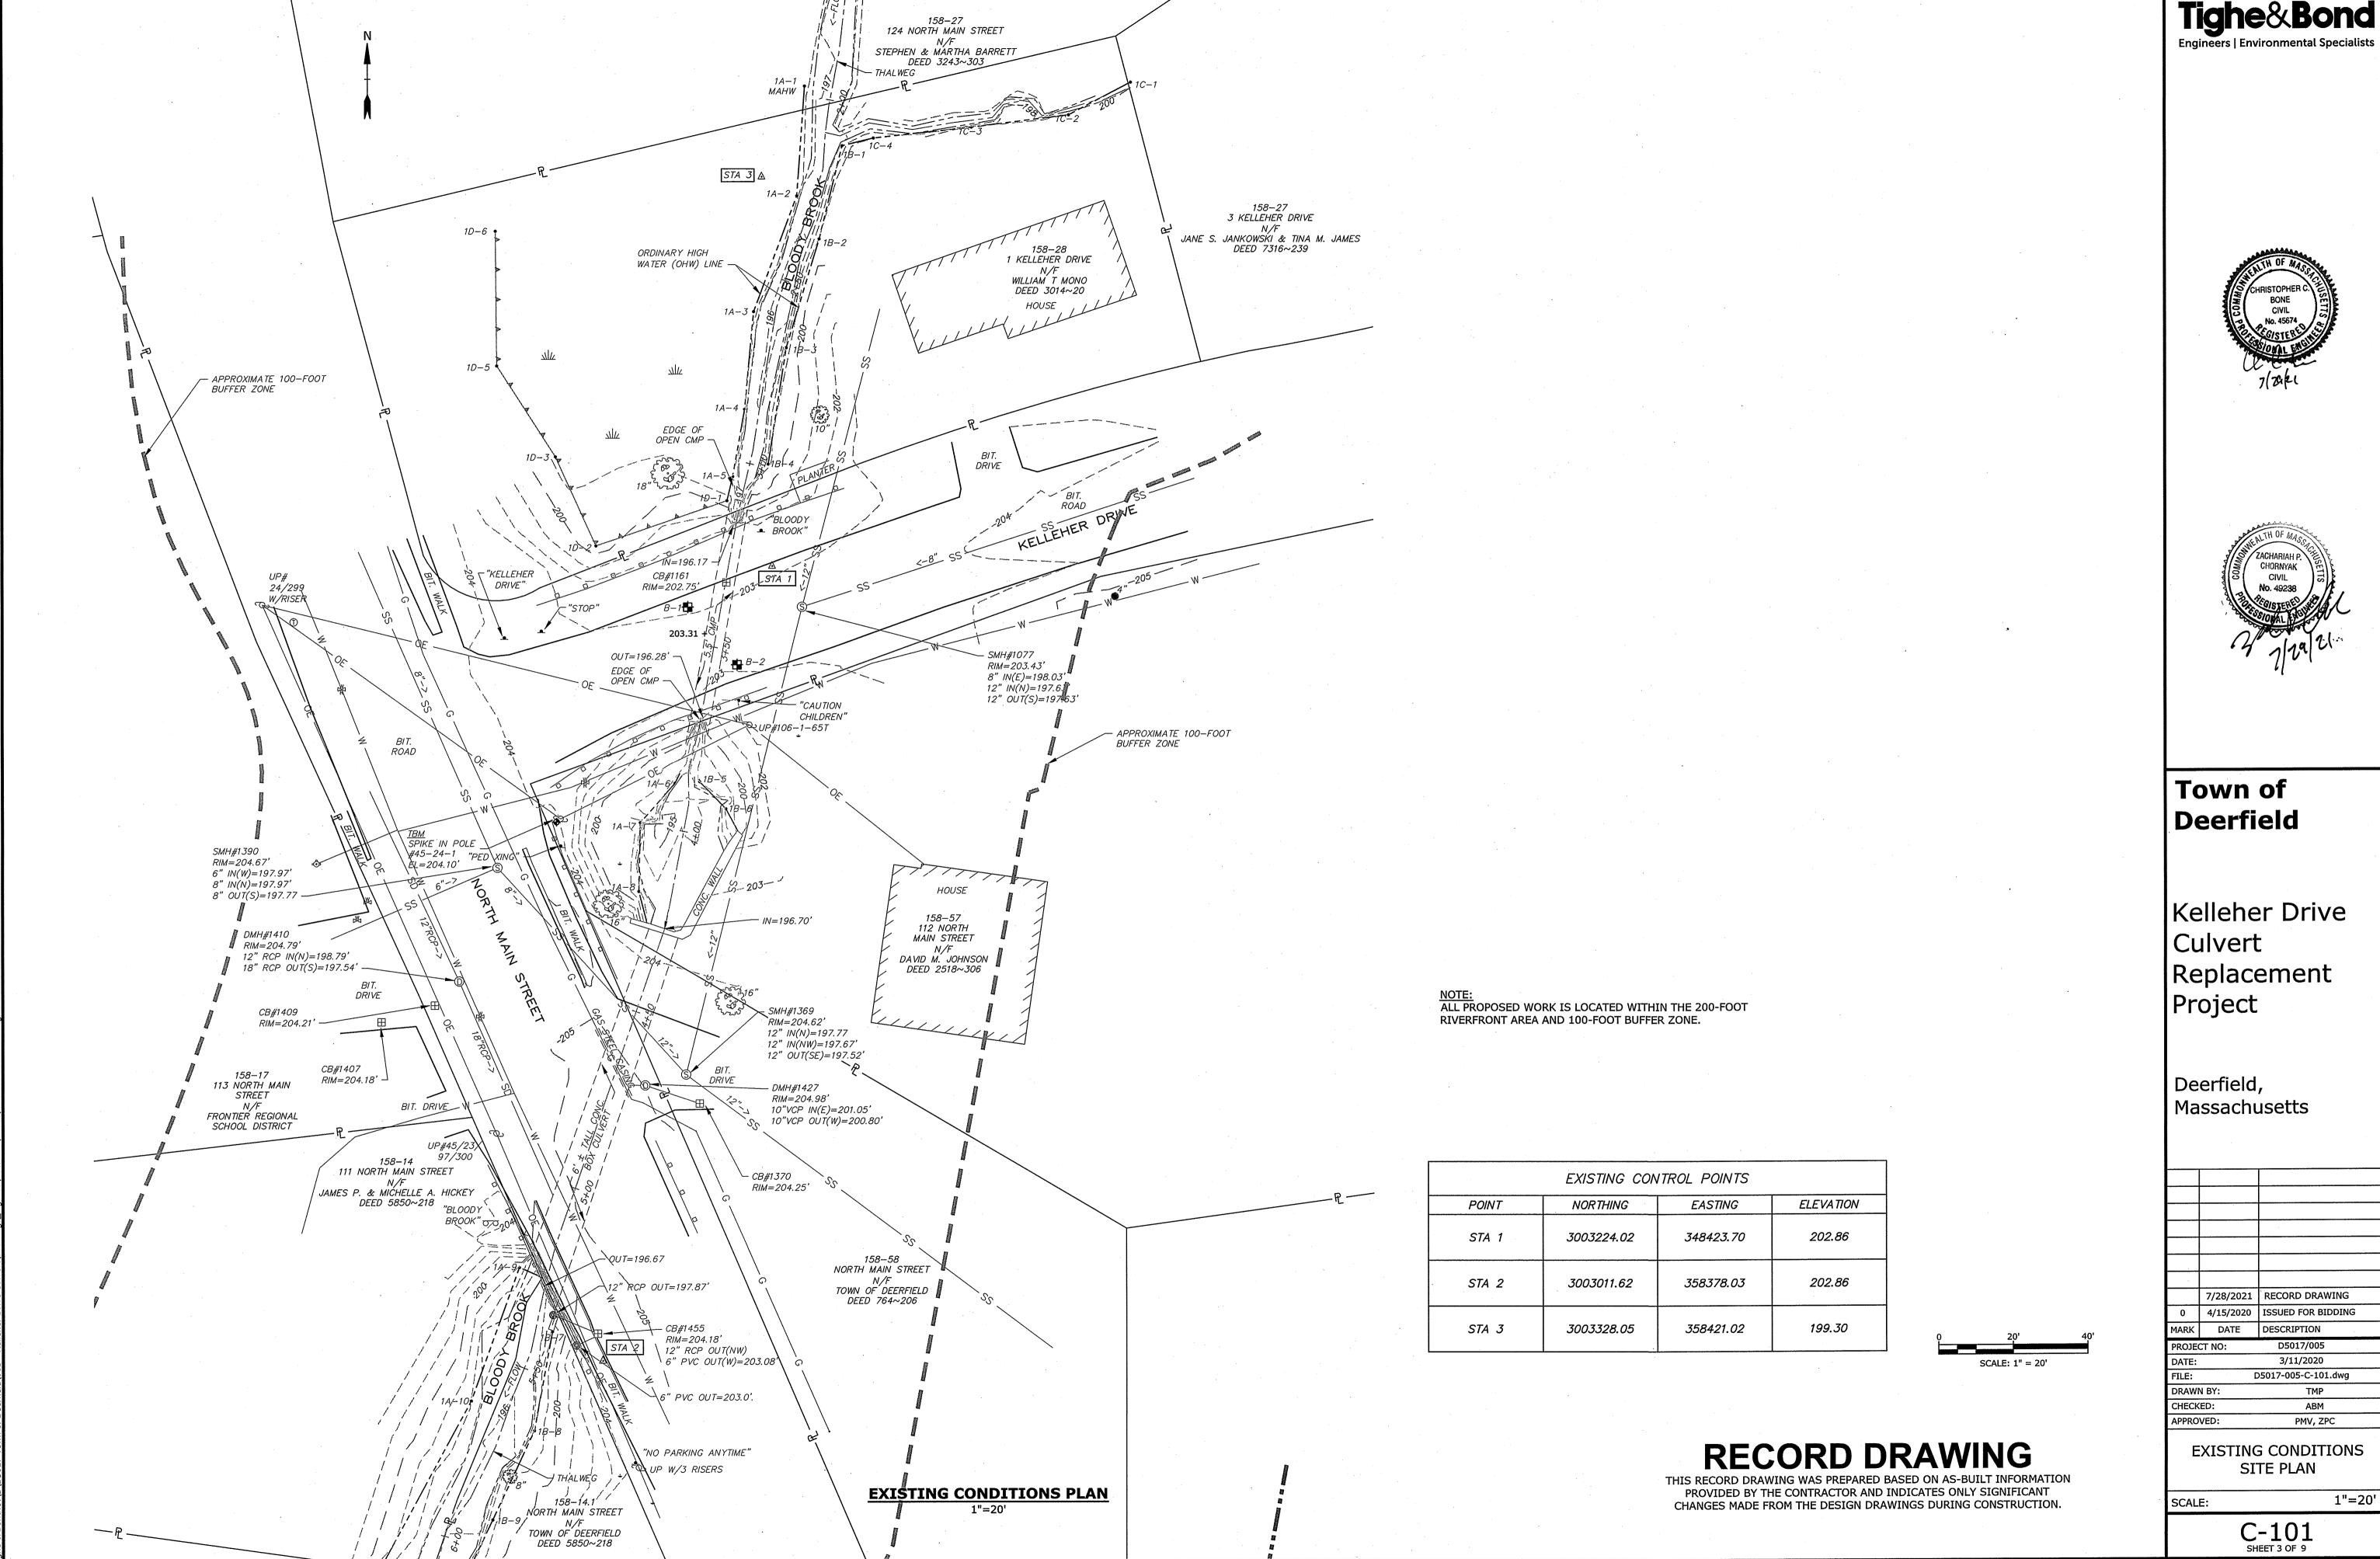
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G-002 SHEET 2 OF 9

RECORD DRAWING


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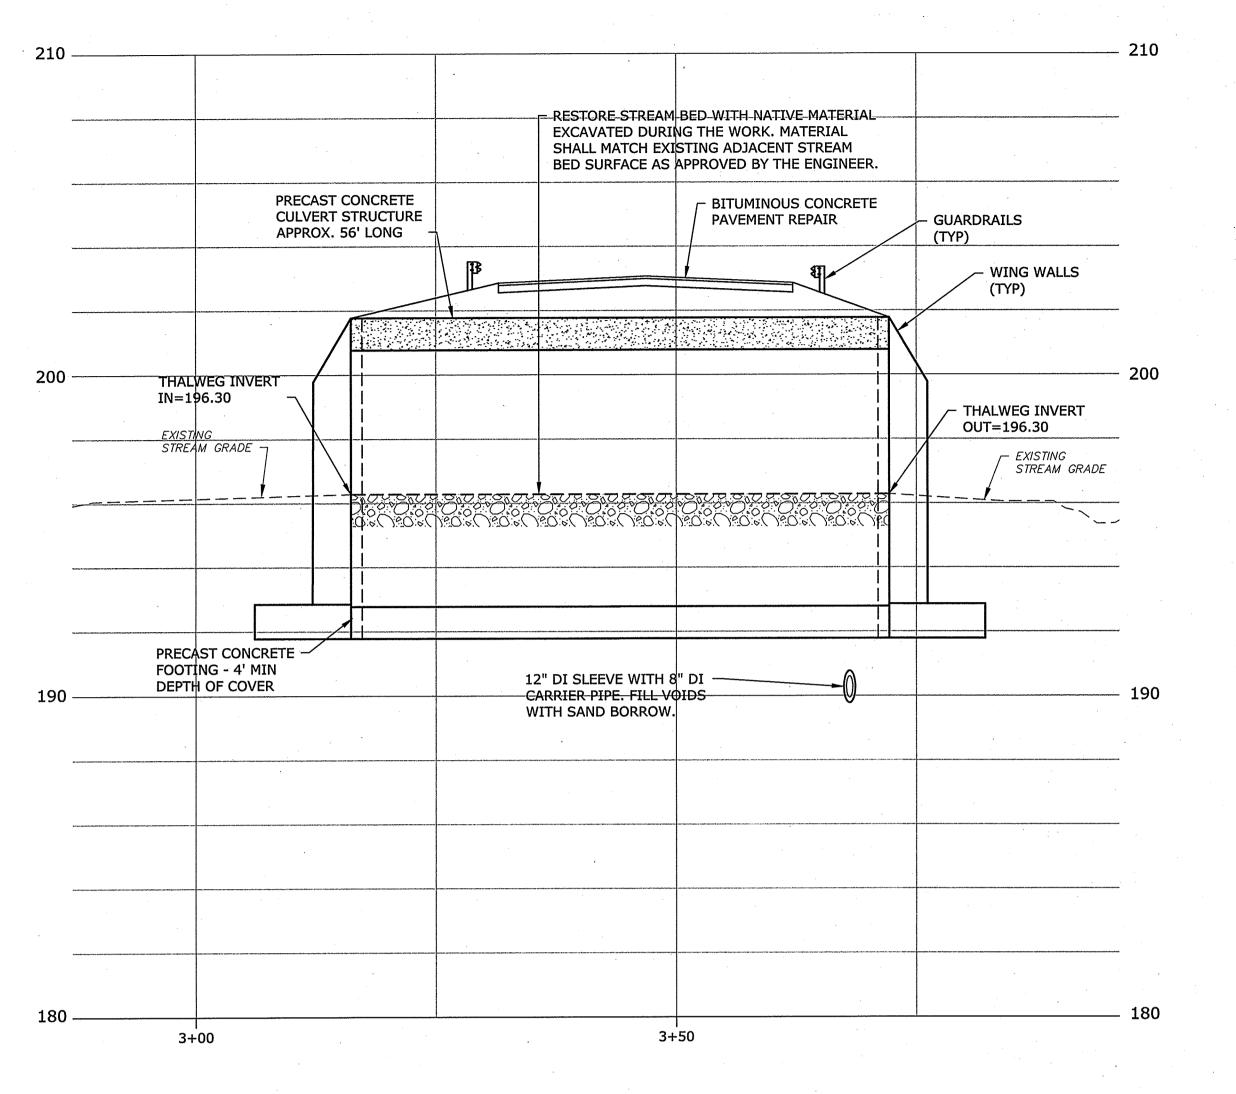


Tighe&Bond


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0	4/15/2020	ISSUED FOR BIDDING	
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PROJECT NO:		D5017/005	
DATE:		3/11/2020	
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EXISTING CONDITIONS



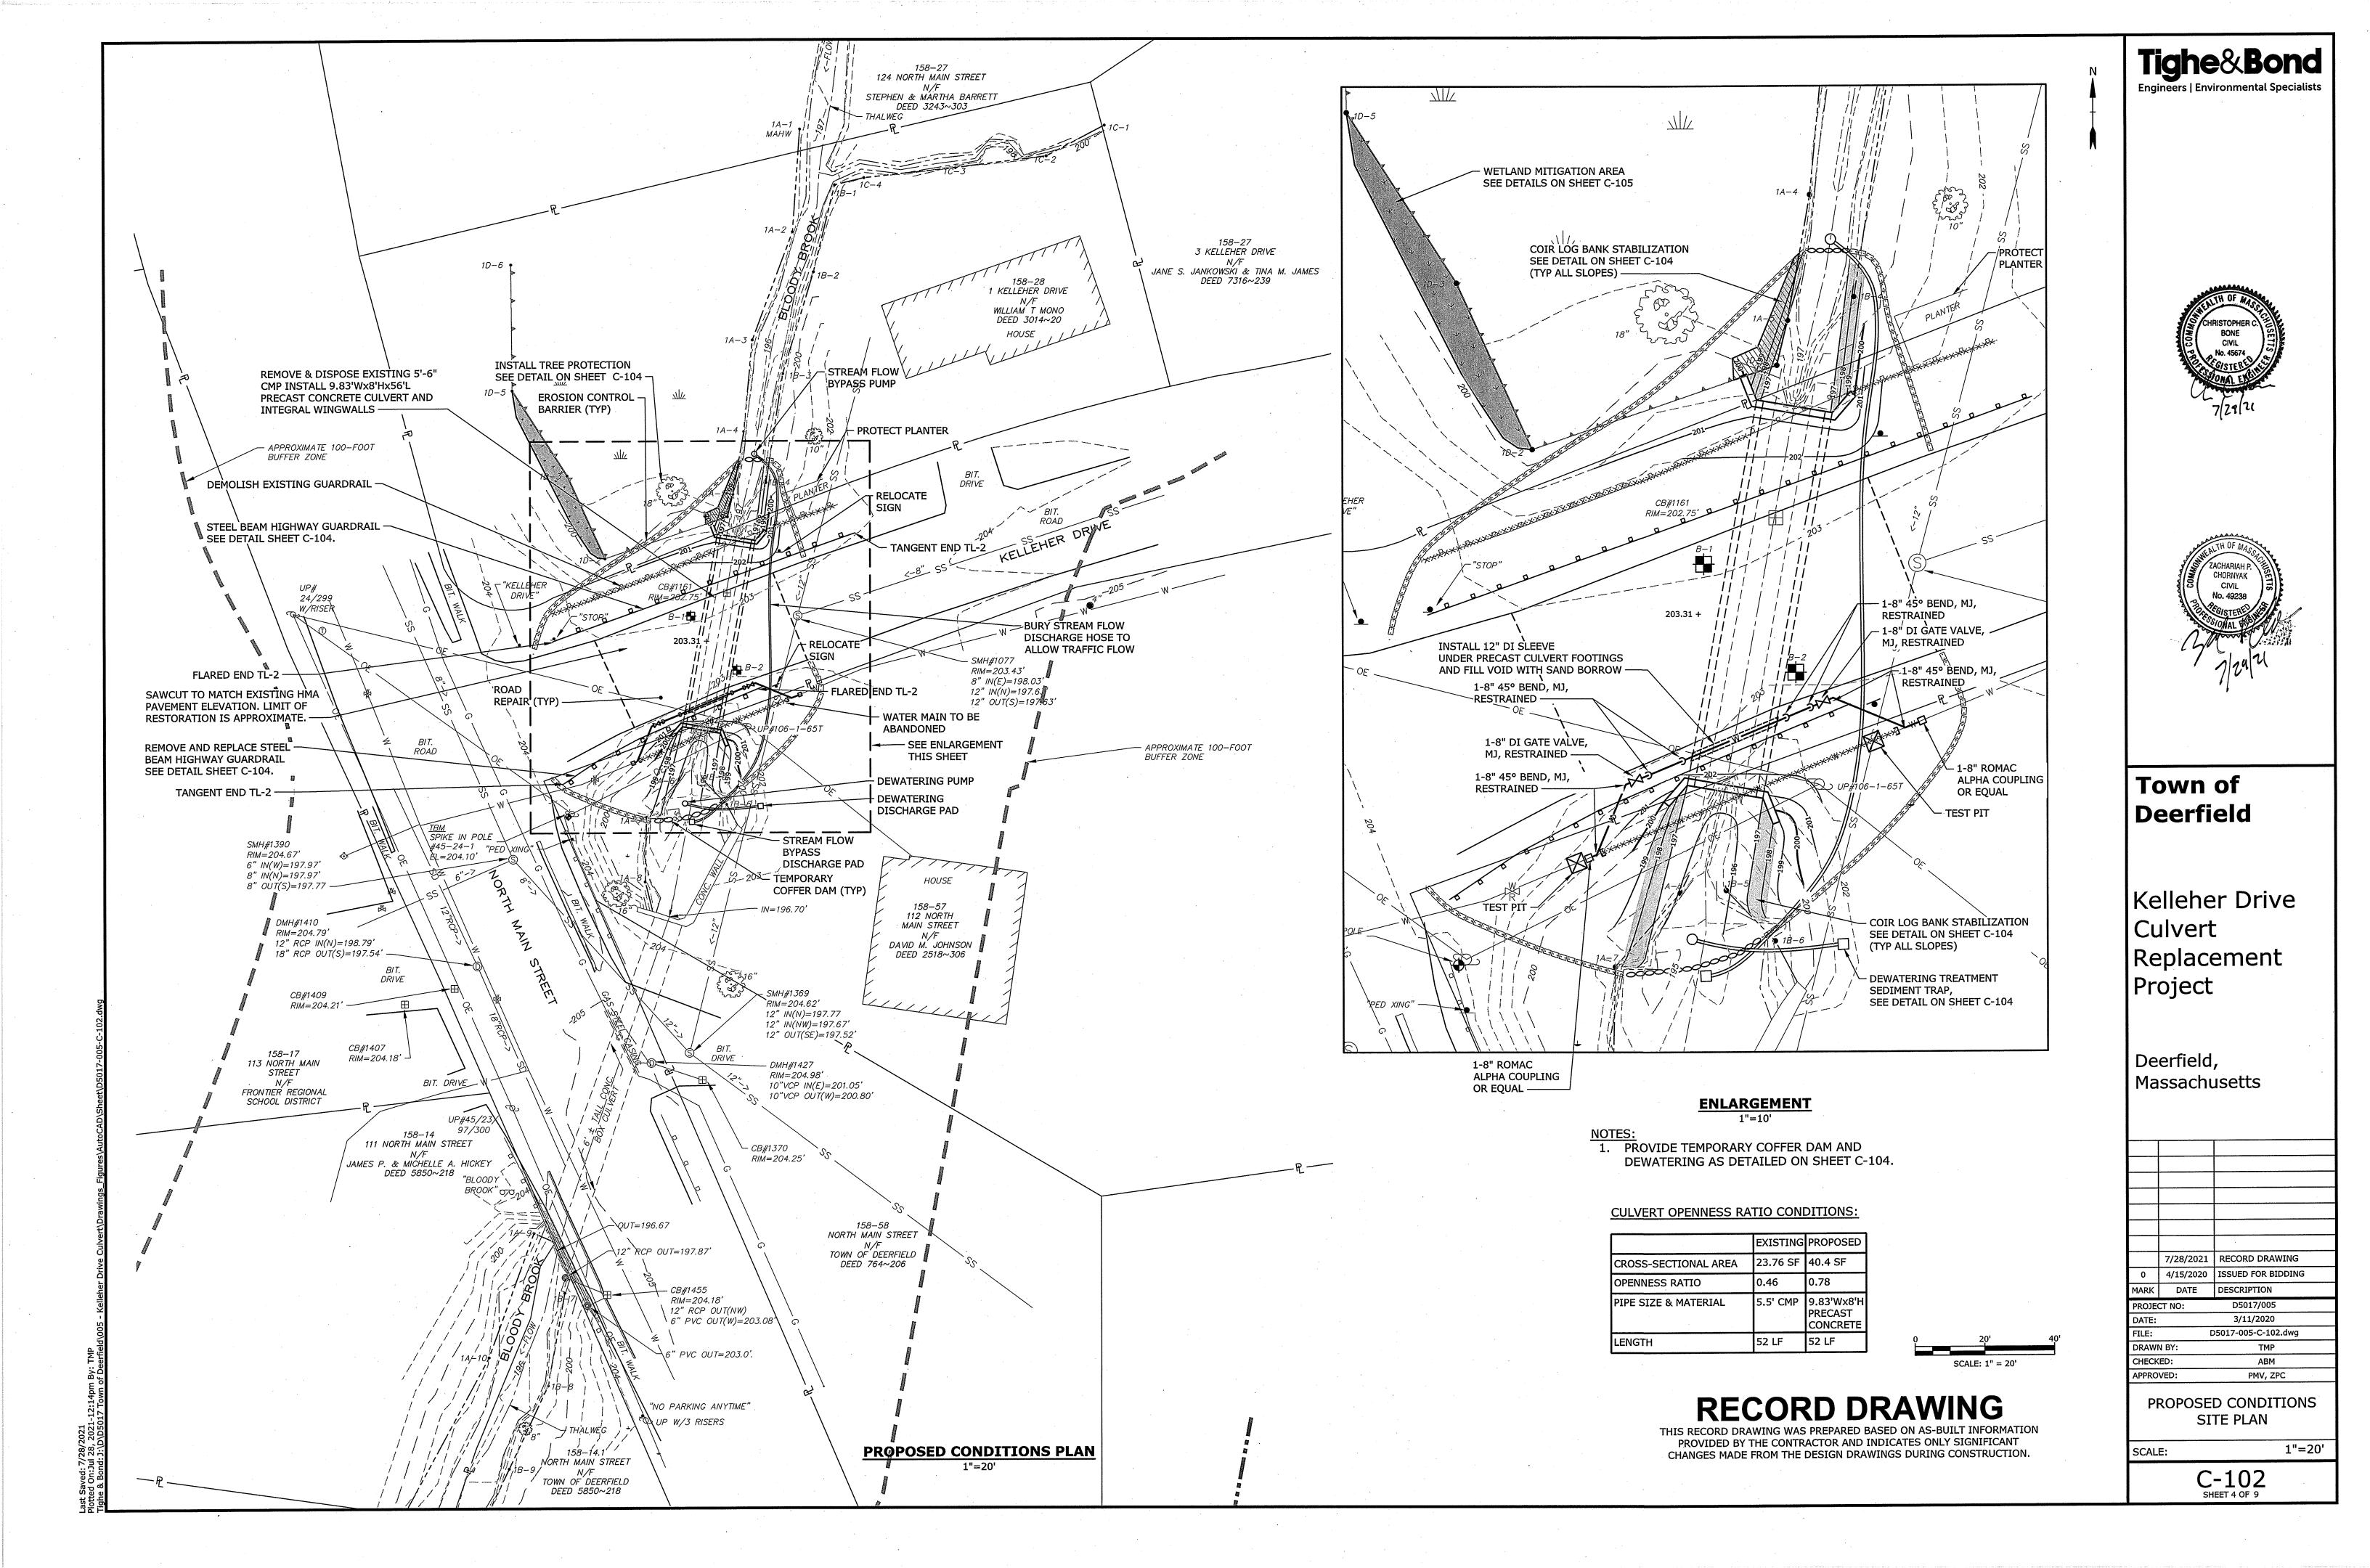

RESTORE STREAM BED WITH NATIVE MATERIAL REMOVED DURING EXCAVATION, TO THE EXTENT POSSIBLE, AND AS APPROVED BY THE ENGINEER/OWNER. IMPORTED MATERIAL SHALL MATCH EXISTING STREAM BED CHARACTERISTICS, INCLUDING GRADATION IMMEDIATELY UPSTREAM AND DOWNSTREAM OF CULVERT. WASH FINES TO COMPACT. FILL VOIDS TO PREVENT SUBSURFACE WATER MIGRATION.

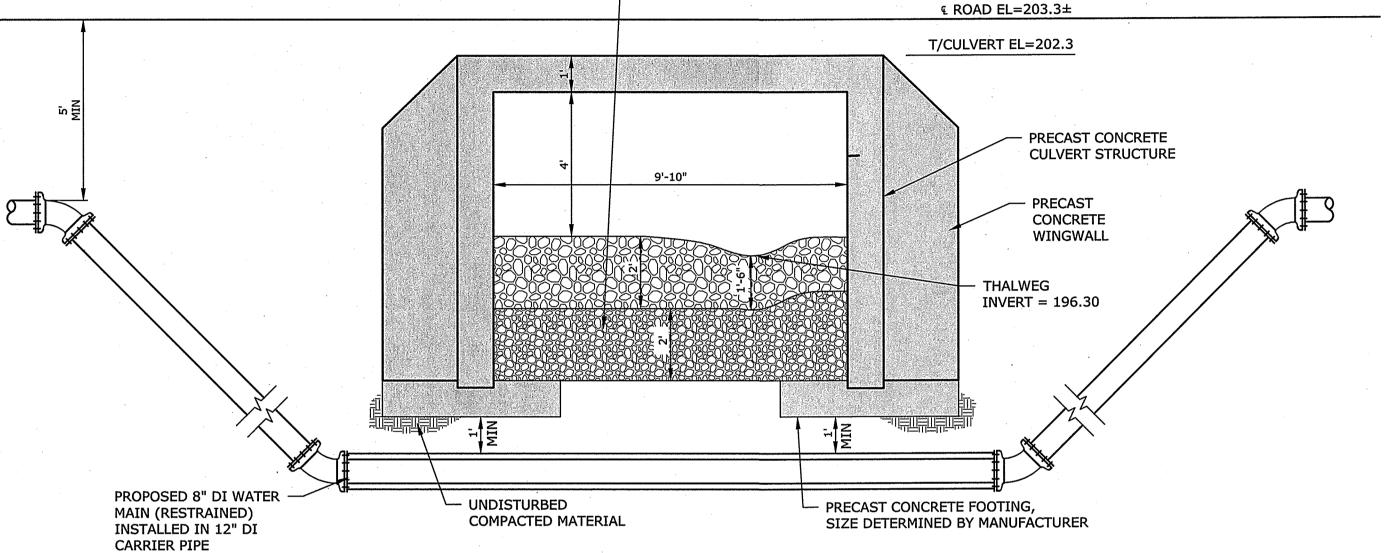


NOTE:
WINGWALL FOOTINGS NOT SHOWN FOR CLARITY

ELEVATION VIEW OF CULVERT

3/8"=1'-0"



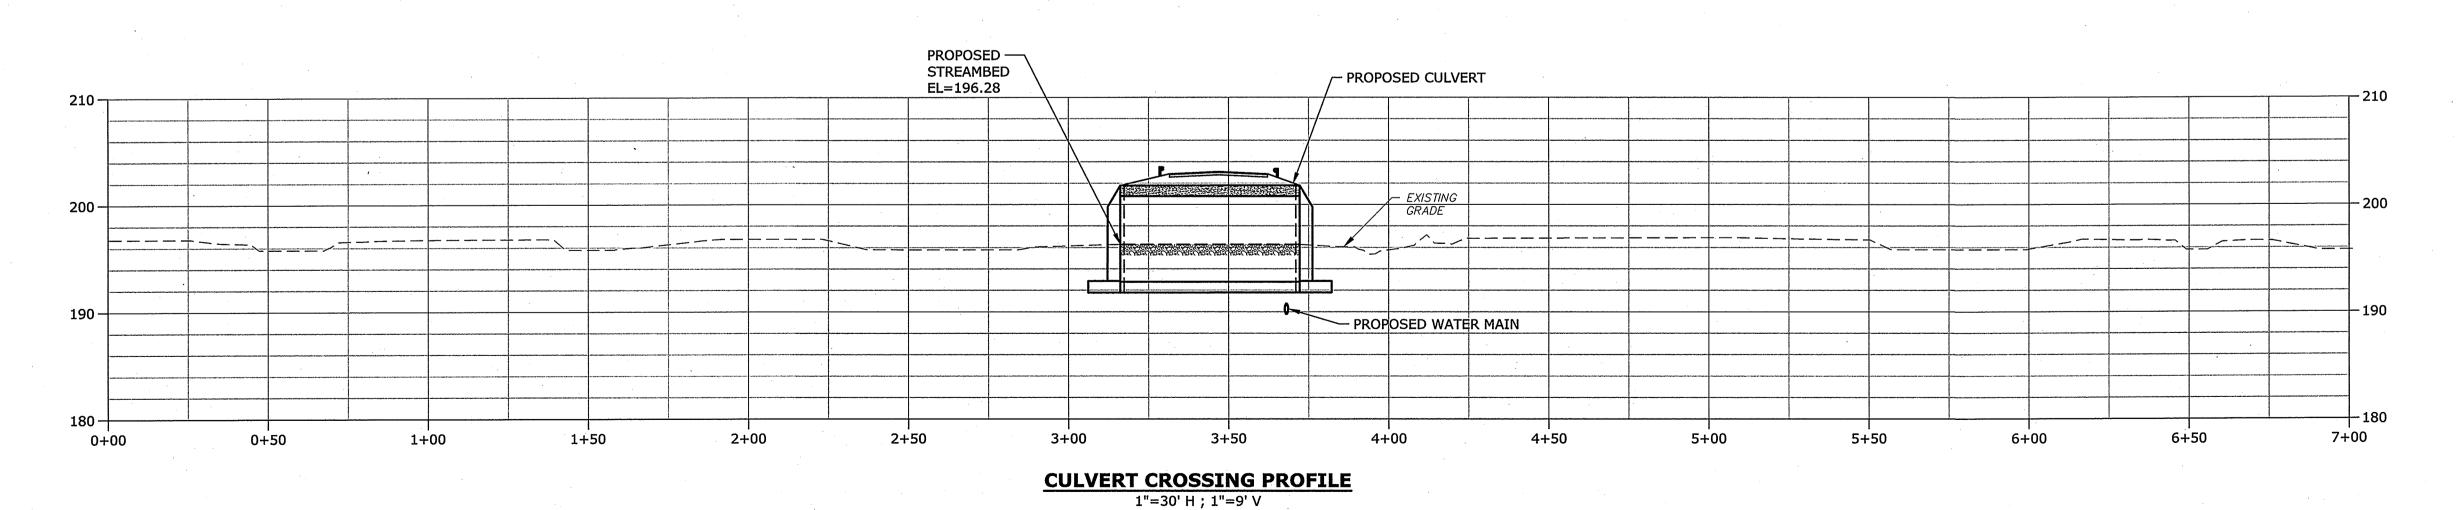


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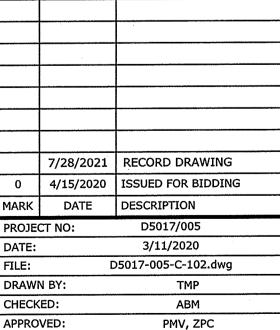




Town of Deerfield

Kelleher Drive Culvert Replacement Project

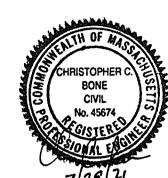Deerfield, Massachusetts




PROPOSED CONDITIONS
PROFILE


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AS SHOWN


C-103

STRAW WATTLE & SILTATION FENCE NO SCALE



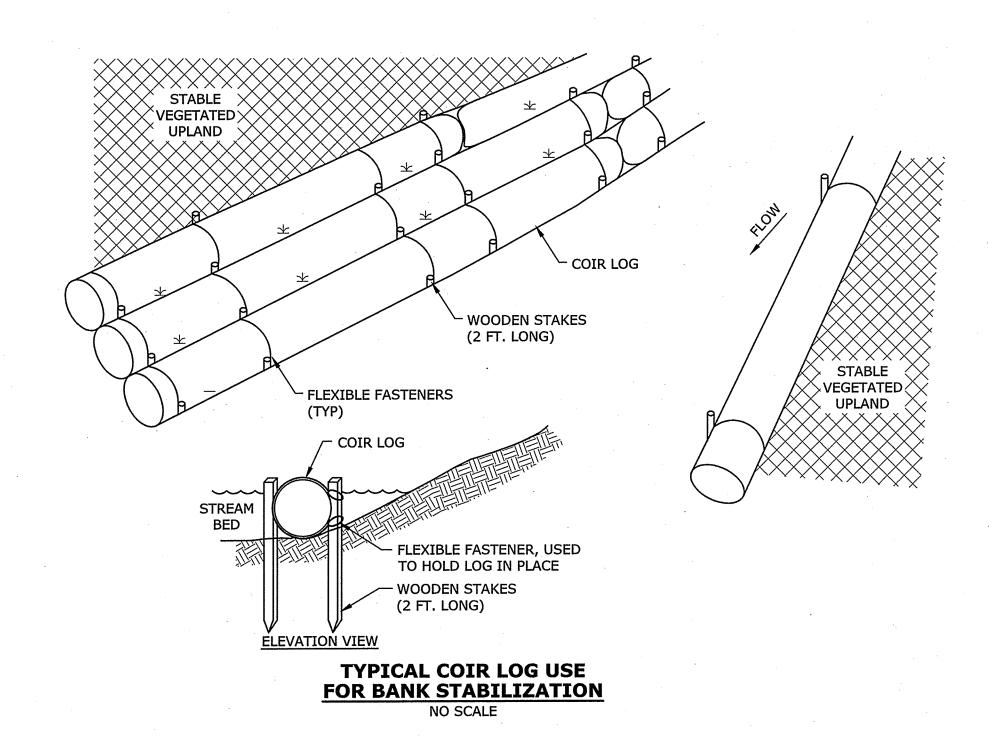


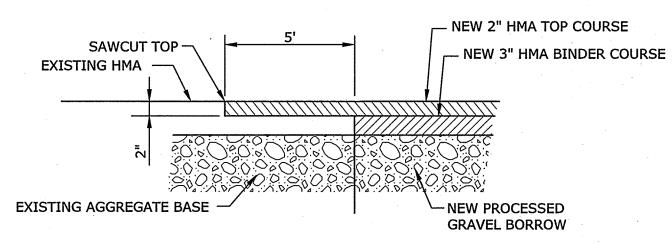TYPICAL BUTT JOINT TO EXISTING PAVEMENT NO SCALE

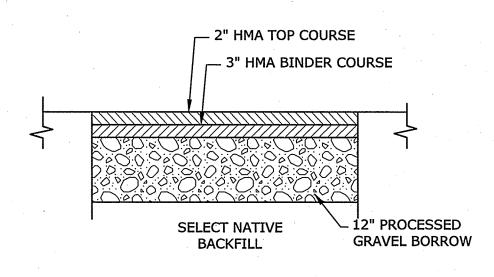


PERMANENT ROADWAY REPAIR

NO SCALE

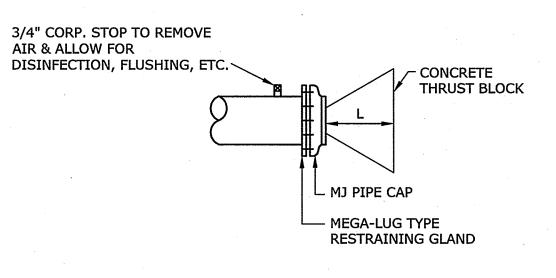

WATER MAIN CAPPING DETAIL

NO SCALE

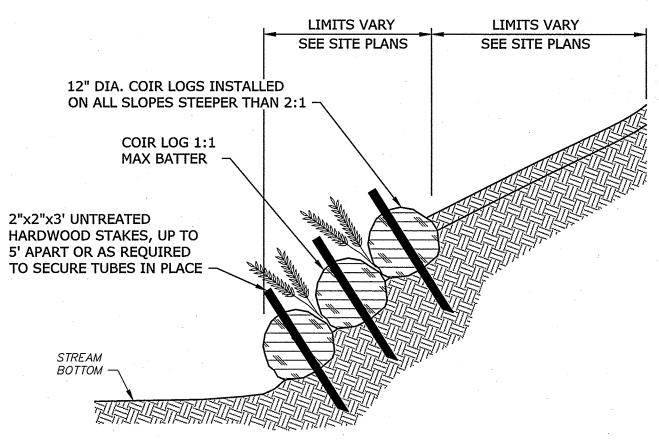


1. DETAIL SHOWN DIAGRAMATICALLY. STABILIZATION IMPROVEMENTS TO


2. SLOPE AREAS SLOPES STEEPER THAN 2:1:

BE INSTALLED PER SITE PLAN GRADING.

COIR LOGS AND LIVE STAKINGS SLOPES FLATTER THAN 2:1: 4" LOAM BORROW, FINISH WITH HYDROSEED AND BONDED FIBER MATRIX.

BANK STABILIZATION

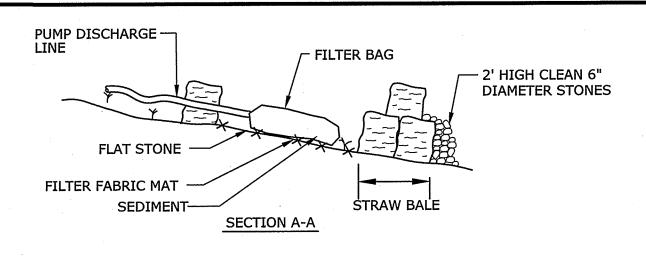

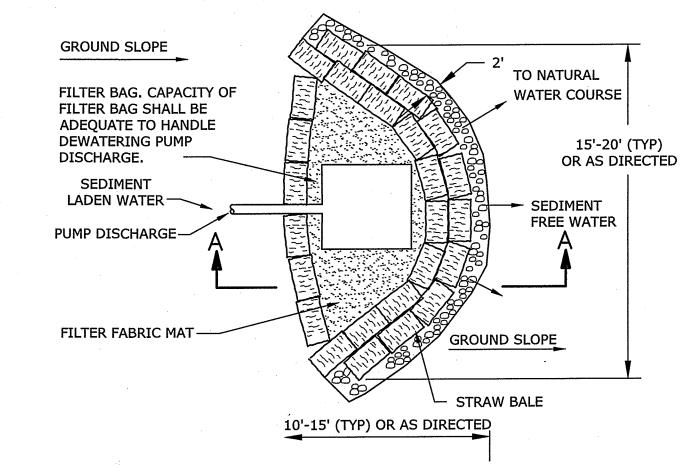

DEWATERING TREATMENT SEDIMENT TRAP NO SCALE

DEWATERING TREATMENT SEDIMENT TRAP SEE DETAIL ABOVE DISCHARGE HOSE TEMPORARY COFFER DAM (SANDBAGS) TEMPORARY COFFER DAM— (SANDBAGS)

> PLAN VIEW - PUMP COFFERDAM **COFFER DAM AND STREAMFLOW BYPASS**

> > NO SCALE

RECORD DRAWING

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Town of Deerfield

CHORNYAK

Engineers | Environmental Specialists

Kelleher Drive Culvert Replacement Project

Deerfield, Massachusetts

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	7/28/2021	RECORD DRAWING
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ATE:		3/11/2020
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RAWN BY:		ТМР
HECKED:		ABM

CONSTRUCTION DETAILS

PMV, ZPC

NO SCALE

APPROVED:

SCALE:

C-104

NO SCALE

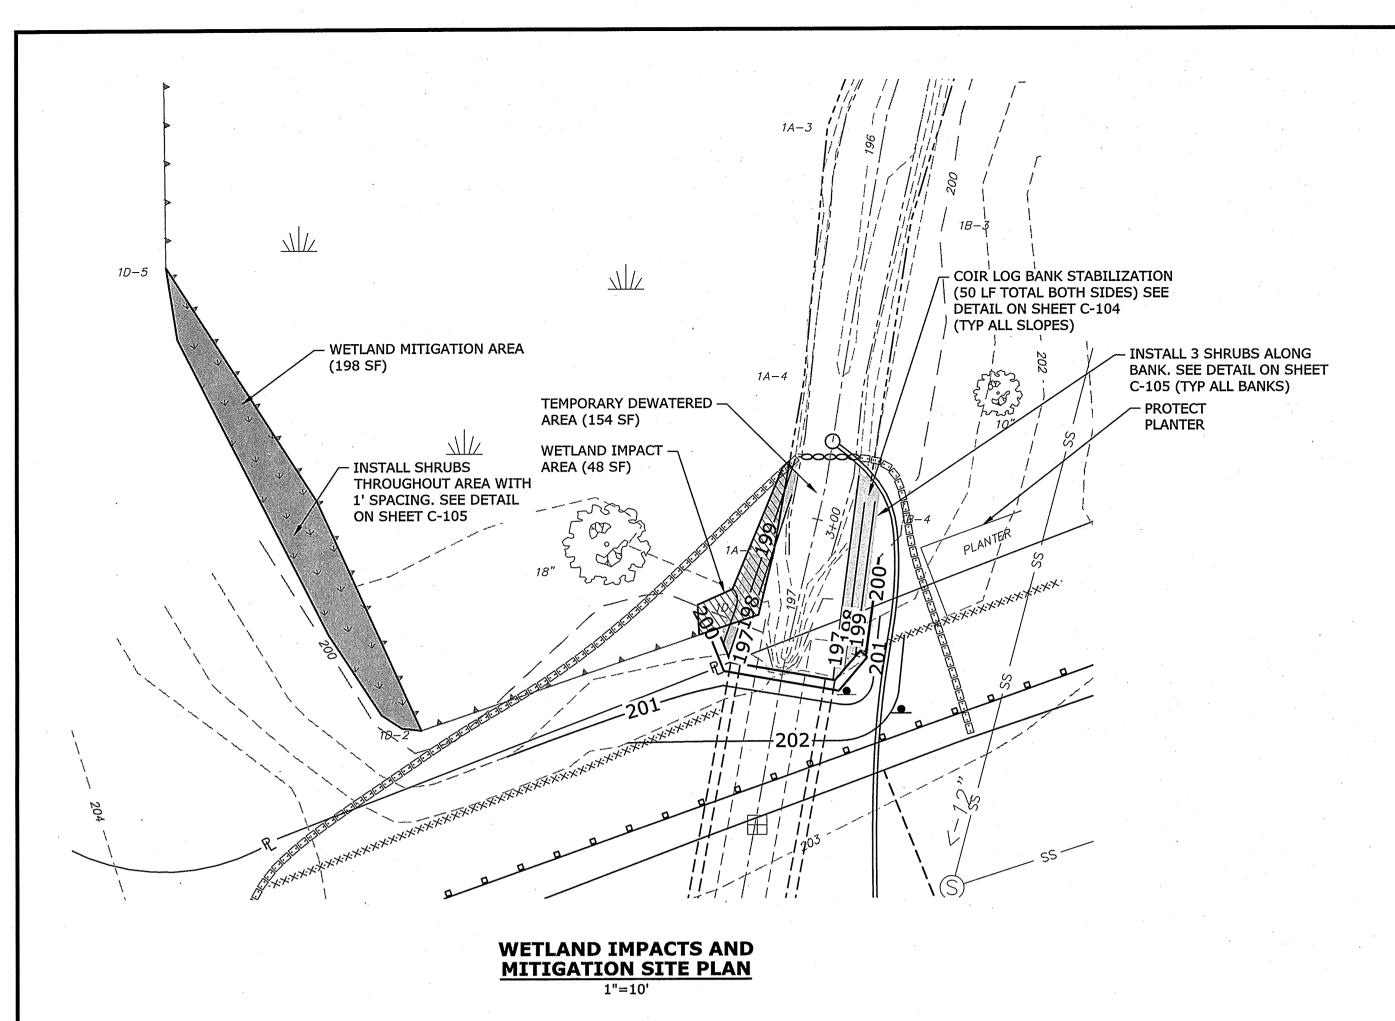


TABLE 1

Native Shrubs for Wetland and Bank Restoration

Common Name

Scientific Name

Size²

Proposed Plantings

Silky Dogwood

Cornus amomum

3'-4'

8

Common Winterberry

Ilex verticillata

3'-4'

4

TABLE 2

New England Erosion Control/Restoration Mix for Dry Sites - Upland Seed Mix **Indicator Status Common Name Scientific Name** FACU Canada Wild Rye Elymus canadensis **FACU** Red Fescue Festuca rubra Annual Ryegrass Lolium multiflorum Perennial Ryegrass Lolium perenne FACU Little Bluestem Schizachyrium scoparium FAC Switch Grass Panicum virgatum

Sorghastrum nutans


TABLE 3

Indian Grass

New England Erosion Control/Restoration Mix for Detention Basins and Moist Sites - Wetland Seed Mix

UPL

Common Name	Scientific Name	Indicator Status	
Riverbank Wild Rye	Elymus riparius	FACW	
Little Bluestem	Schizachyrium scoparium	FACU	
Red Fescue	Festuca rubra	FACU	
Big Bluestem	Andropogon gerardii	FAC	
Switch Grass	Panicum virgatum	FAC	
New York Ironweed	Vernonia noveboracensis	FACW	
Upland Bentgrass	Agrostis perennans	FACU	
Beggar Ticks	Bidens frondosa	FACW	•
Spotted Joe Pye Weed	Eupatorium maculatum	OBL	
Boneset	Eupatorium perfoliatum	FACW	
New England Aster	Aster novae-angliae	FACW	
Wool Grass	Scirpus cyperinus	FACW	
Soft Rush	Juncus effusus	FACW	

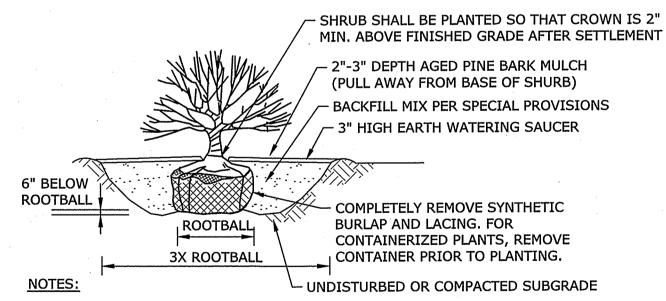

- 1. RAISE AND REPLANT ANY SHRUBS WHICH SETTLE MORE THAN 2" AFTER PLANTING AND WATERING IN.
- 2. SHRUBS SHALL BE SET PLUMB.
- 3. WATER BY FLOODING TWICE IN FIRST TWO HOURS AFTER PLANTING. WATER AND MAINTAIN AS PER STANDARD SPECIFICATIONS.
- 4. LOOSE OR CRACKED ROOTBALLS WILL NOT BE ACCEPTED FOR PLANTING.

SHRUB PLANTING DETAIL
NO SCALE

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Town of Deerfield

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WETLAND RESTORATION
DETAILS

TMP

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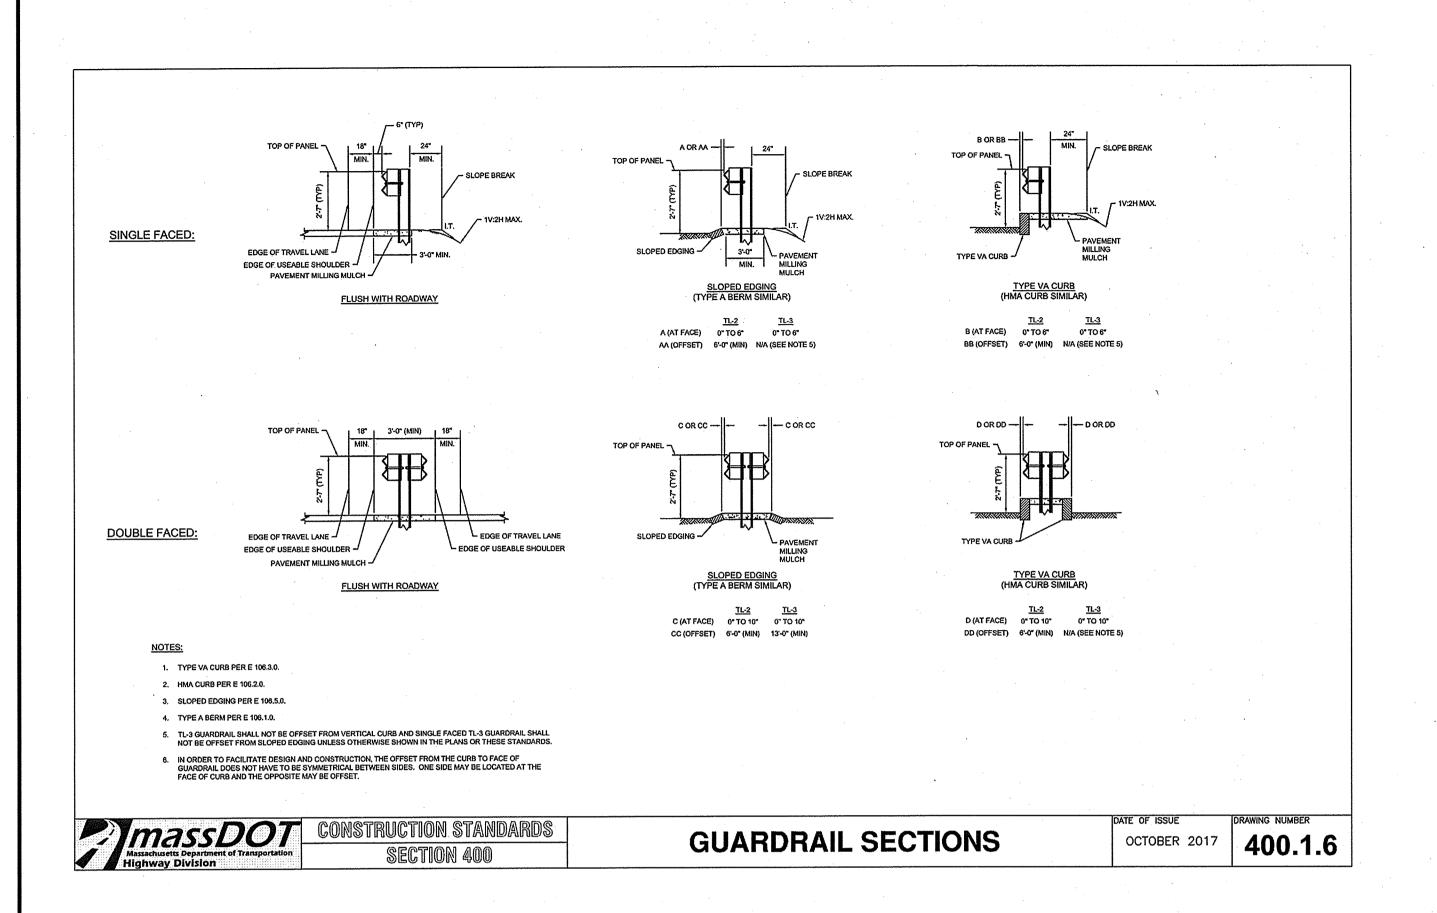
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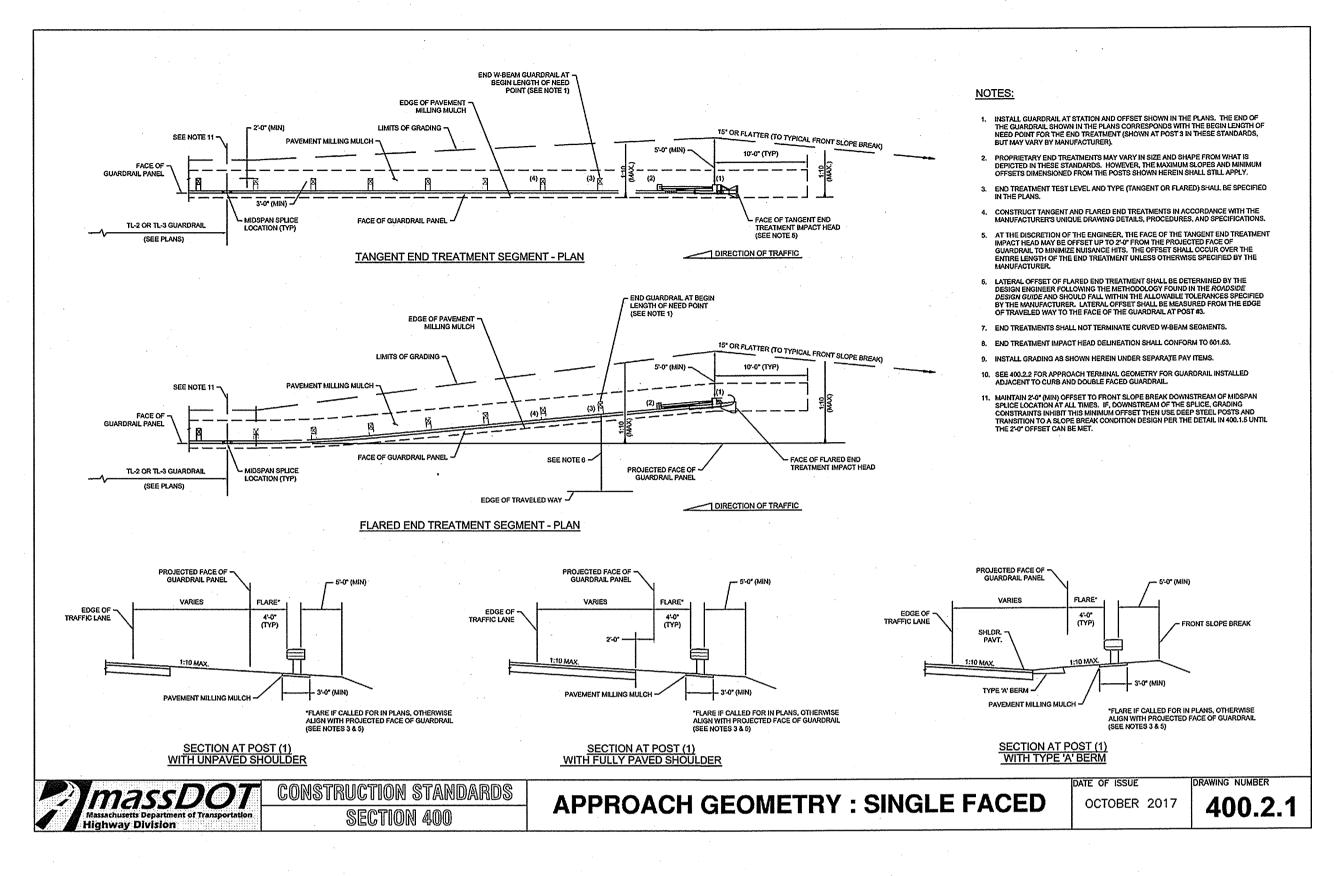
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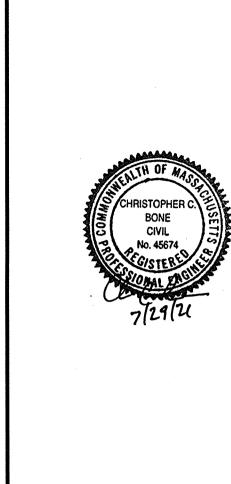
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C-105 SHEET 7 OF 9







Tighe&Bond



Town of Deerfield

Kelleher Drive Culvert Replacement Project


Deerfield, Massachusetts

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DRAWN BY:		ТМР
CHECKED:		ABM
APPROVED:		PMV, ZPC

GUARDRAIL DETAILS


E: NO SCALE

C-106 SHEET 8 OF 9

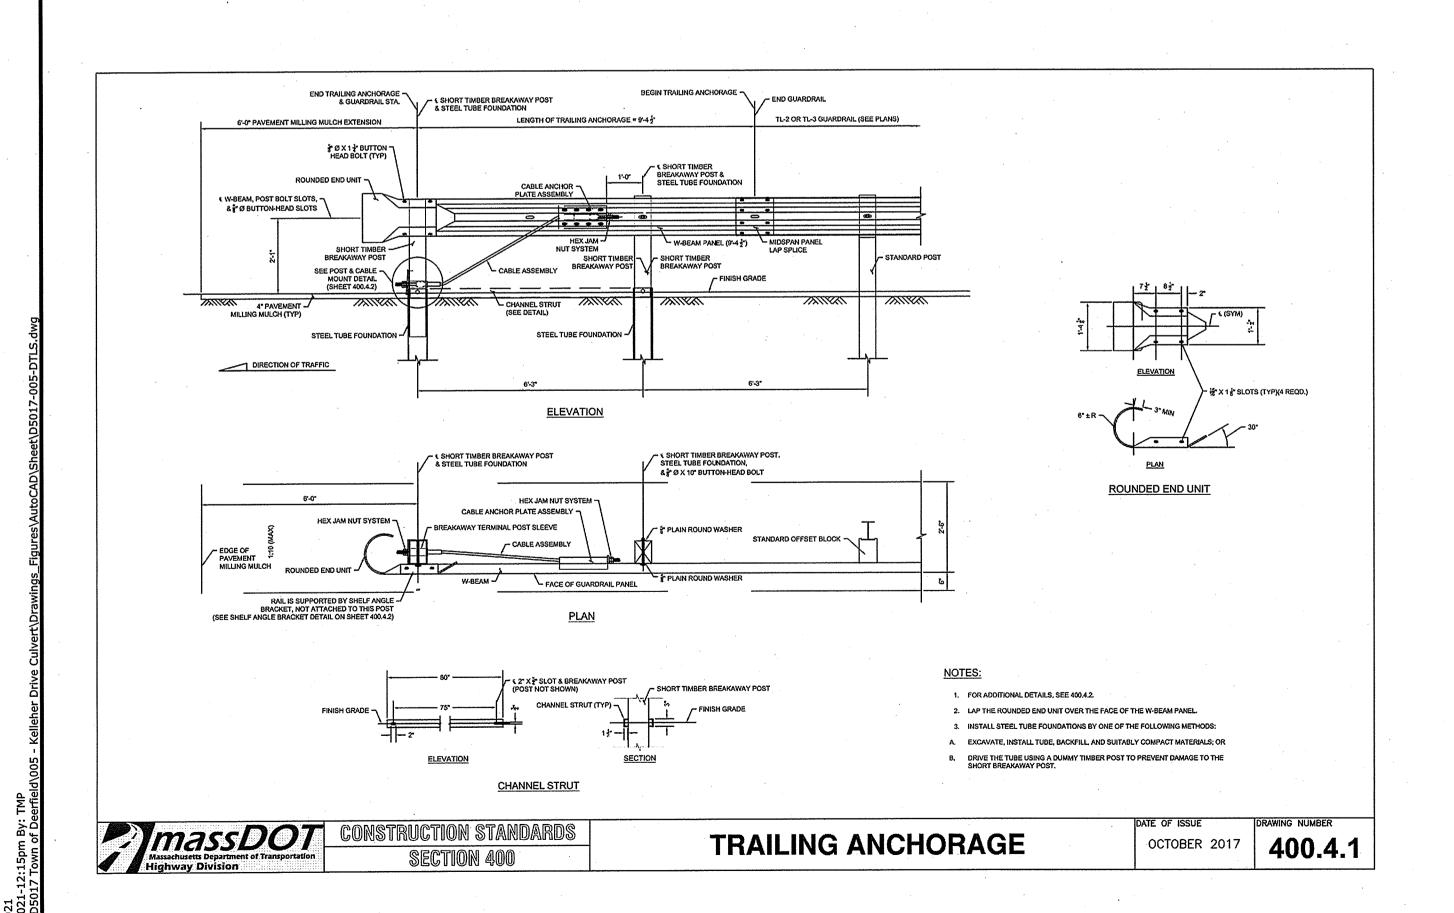

RECORD DRAWING

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	•				
IDENTIFICATION NUMBER		F SIGN N) HEIGHT	TEXT	NUMBER OF SIGNS REQUIRED	AREA IN SQ. FT.
R11-3a	60	30	ROAD CLOSED LOCAL TRAFFIC ONLY	1	13
W20-4	48	48	ONE LANE ROAD AHEAD	1	16
W20-8	.48	48	POLICE OFFICER AHEAD	1	16
			TOTAL =	3	45

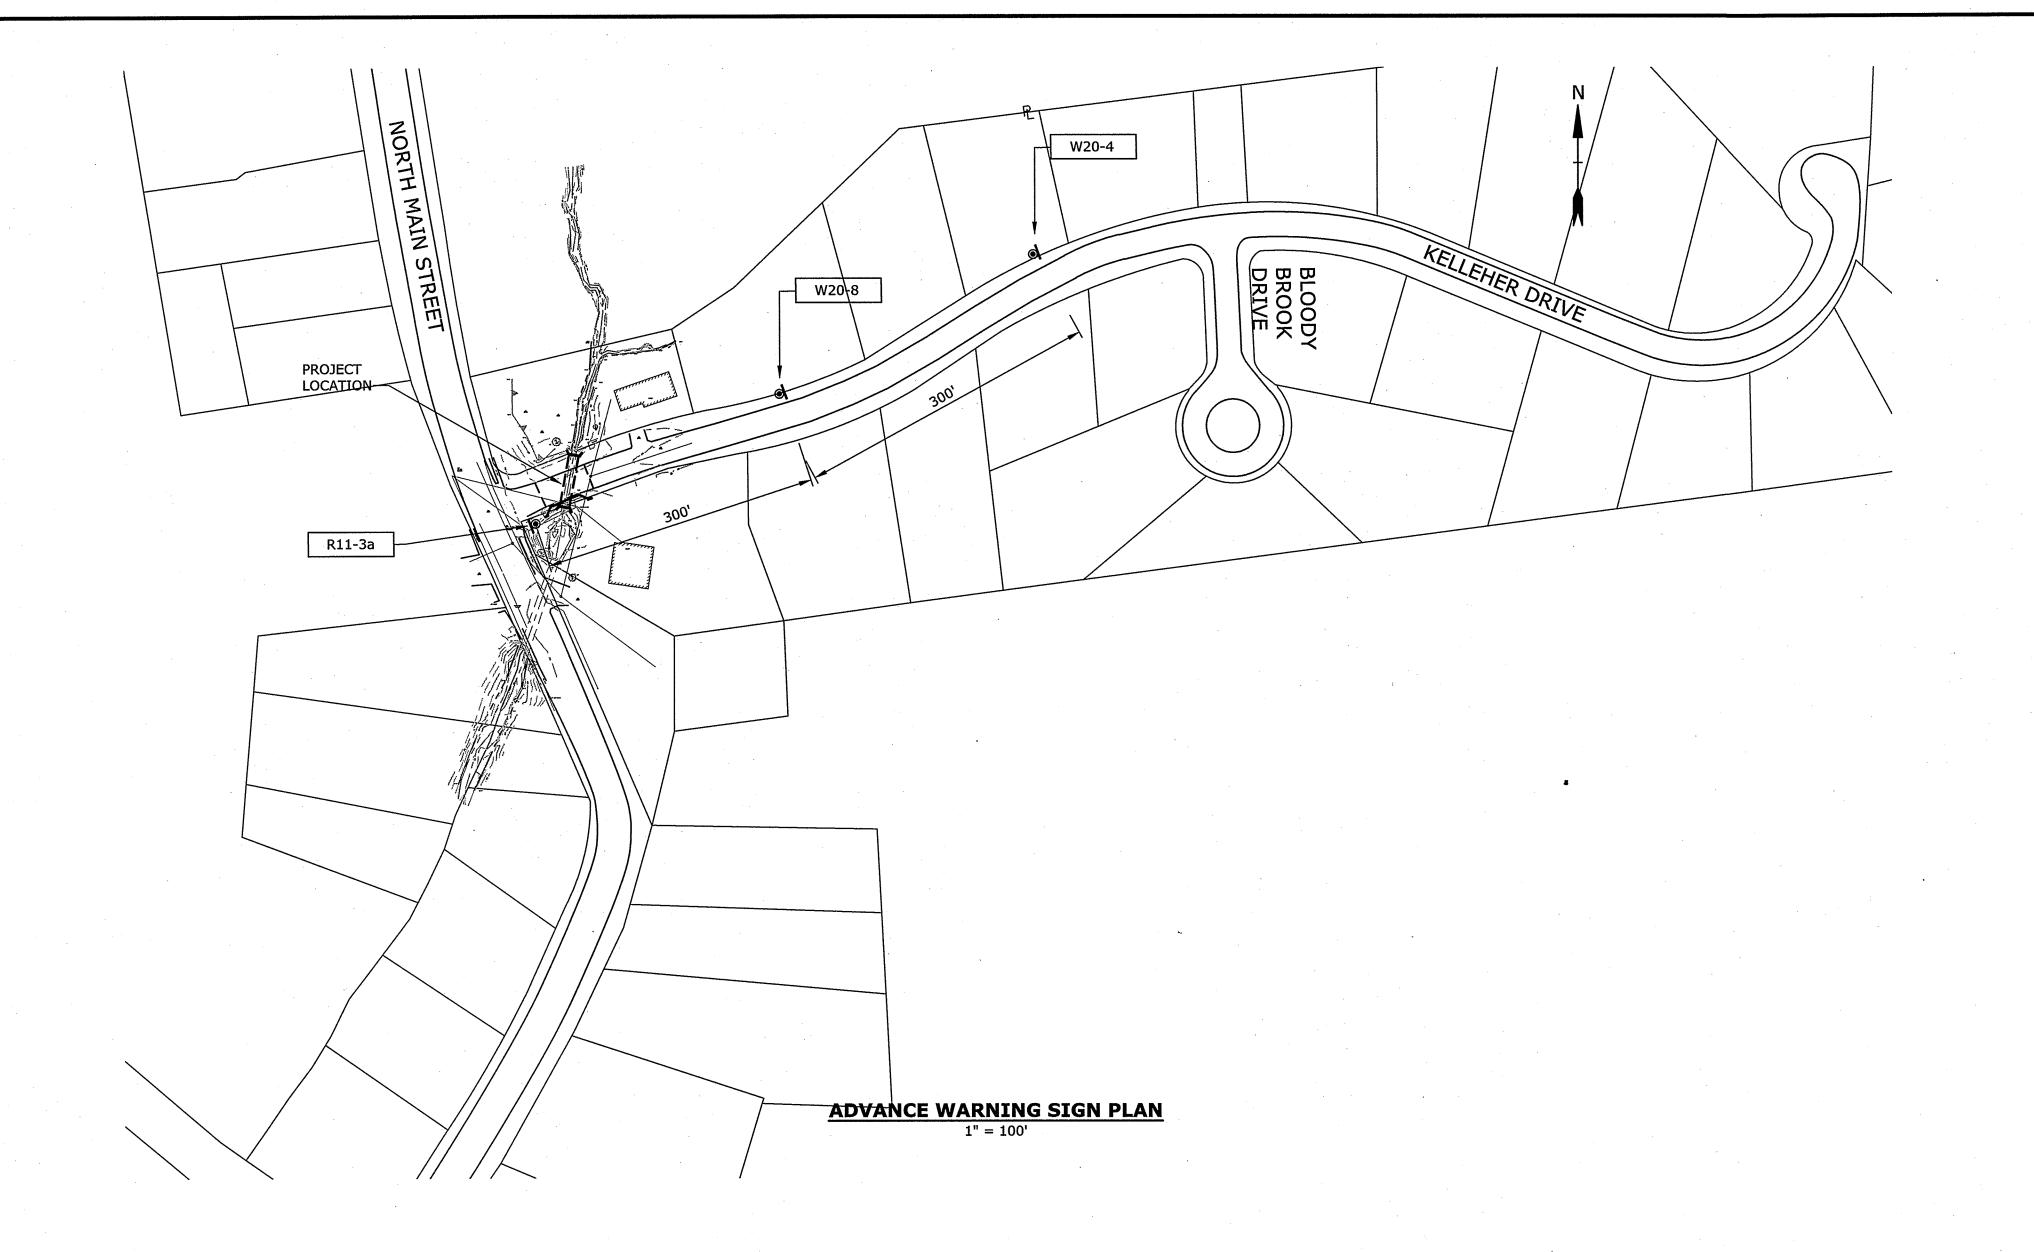TEMPORARY TRAFFIC CONTROL NOTES:

- 1. TEMPORARY FENCING AND BARRIERS SHALL BE DEPLOYED ON SITE DURING THE ROADWAY CLOSURE TO PREVENT ACCESS TO THE CROSSING.
- 2. ALTERNATIVE ONE-WAY TRAFFIC SHALL BE MAINTAINED DURING THE WORK.
- 3. ALL DETOUR SIGNAGE SHALL BE PLACED PRIOR TO THE START OF CONSTRUCTION AND REMOVED IMMEDIATELY FOLLOWING COMPLETION OF THE WORK.
- 4. PLACEMENT OF SIGNS SHALL BE COORDINATED WITH THE ENGINEER AND THE LOCAL POLICE DEPARTMENT (DEERFIELD, MASSACHUSETTS).

Tighe&Bond
Engineers | Environmental Specialists





Town of Deerfield

Kelleher Drive Culvert Replacement Project

Deerfield, Massachusetts

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TEMPORARY TRAFFIC CONTROL

CHECKED:

APPROVED:

SCALE: NO SCALE

C-107 SHEET 9 OF 9

ABM

PMV, ZPC

RECORD DRAWING

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