

# CITY OF CHELSEA, MASSACHUSETTS

# ISLAND END RIVER FLOOD PROTECTION AND RIVERWALK DEPARTMENT OF HOUSING AND COMMUNITY DEVELOPMENT, 500 BROADWAY, CHELSEA, MA 02150

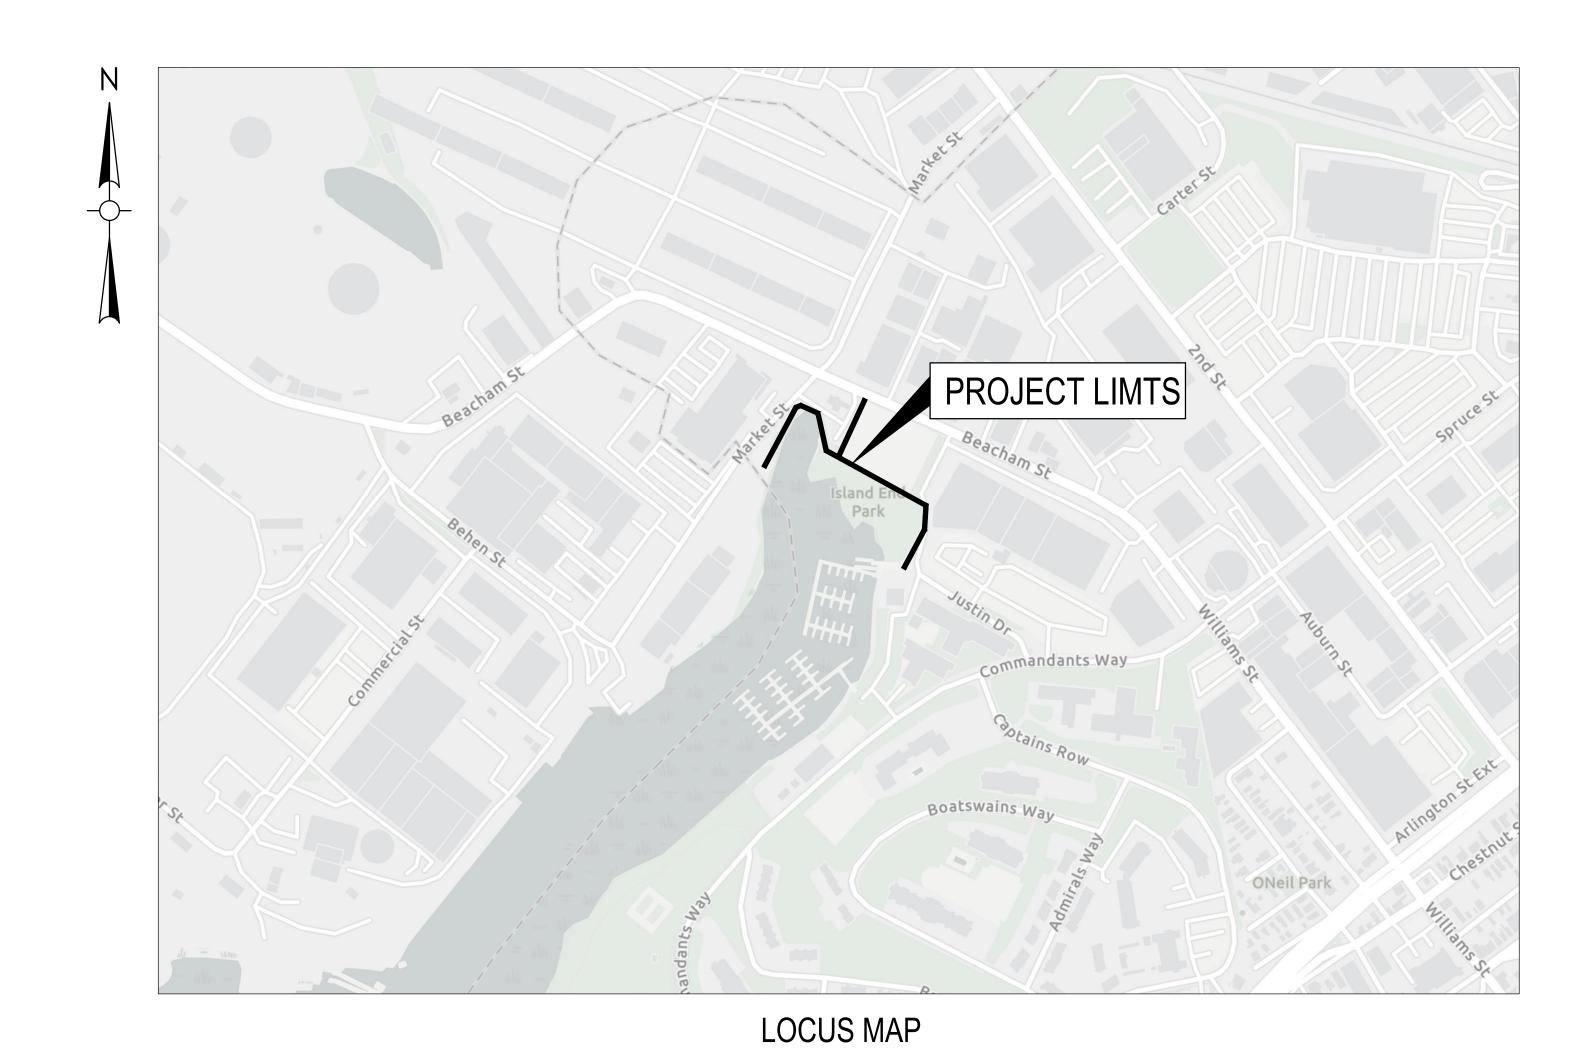

**DRAWING INDEX** SHEET NUMBER: **DRAWING TITLE:** GG001 COVER SHEET AND INDEX VF101 **EXISTING SITE PLAN** VF102 SITE PLANS LIMIT OF WORK CG001 ABBREVIATIONS, NOTES, AND LEGEND CG101 EROSION AND SEDIMENT CONTROL PLAN WETLANDS EXISTING CONDITIONS PLAN CG102 CG103 WETLANDS RESTORATION PLAN **EROSION AND SEDIMENT CONTROL DETAILS** CG501 CG502 WETLANDS RESTORATION DETAILS CD101 SITE DEMOLITION PLAN CU101 **UTILITY PLAN 1** CU102 UTILITY PLAN 2 CU501 **UTILITY DETAILS 1** CU502 UTILITY DETAILS 2 CU503 UTILITY DETAILS 3 CX101 **GRADING PLAN 1** CX102 **GRADING PLAN 2** LS201 MATERIALS PLAN 1 LS202 MATERIALS PLAN 2 LP101 PLANTING PLAN LZ501 LANDSCAPE SITE DETAILS 1 LZ502 LANDSCAPE SITE DETAILS 3 LZ503 LZ504 LANDSCAPE SITE DETAILS 4 LZ505 BERM AND PAVING DETAILS E101 SITE LIGHTING PLAN 1 E102 SITE LIGHTING PLAN 2 E501 SITE LIGHTING DETAILS S101 SHEET PILE WALL AND BOARDWALK PLAN SHEET PILE WALL ELEVATION 1 S201 S202 SHEET PILE WALL ELEVATION 2 S203 SHEET PILE WALL ELEVATION 3 PILE LAYOUT PLAN S401 S402 **BOARDWALK LAYOUT PLAN** STRUCTURAL DETAILS S501 S502 PILE DETAILS RR101 EASEMENT PLAN

THOMAS G. AMBROSINO CITY MANAGER

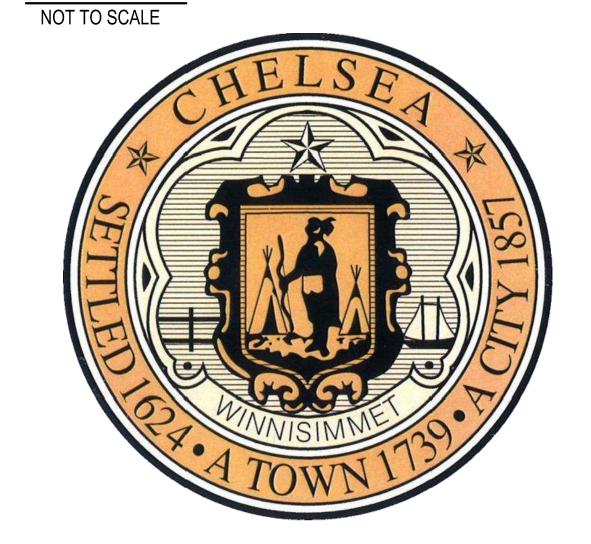



ALEXANDER TRAIN, AICP DIRECTOR OF HOUSING AND COMMUNITY DEVELOPMENT

JUNE 2021



DRAFT DESIGN

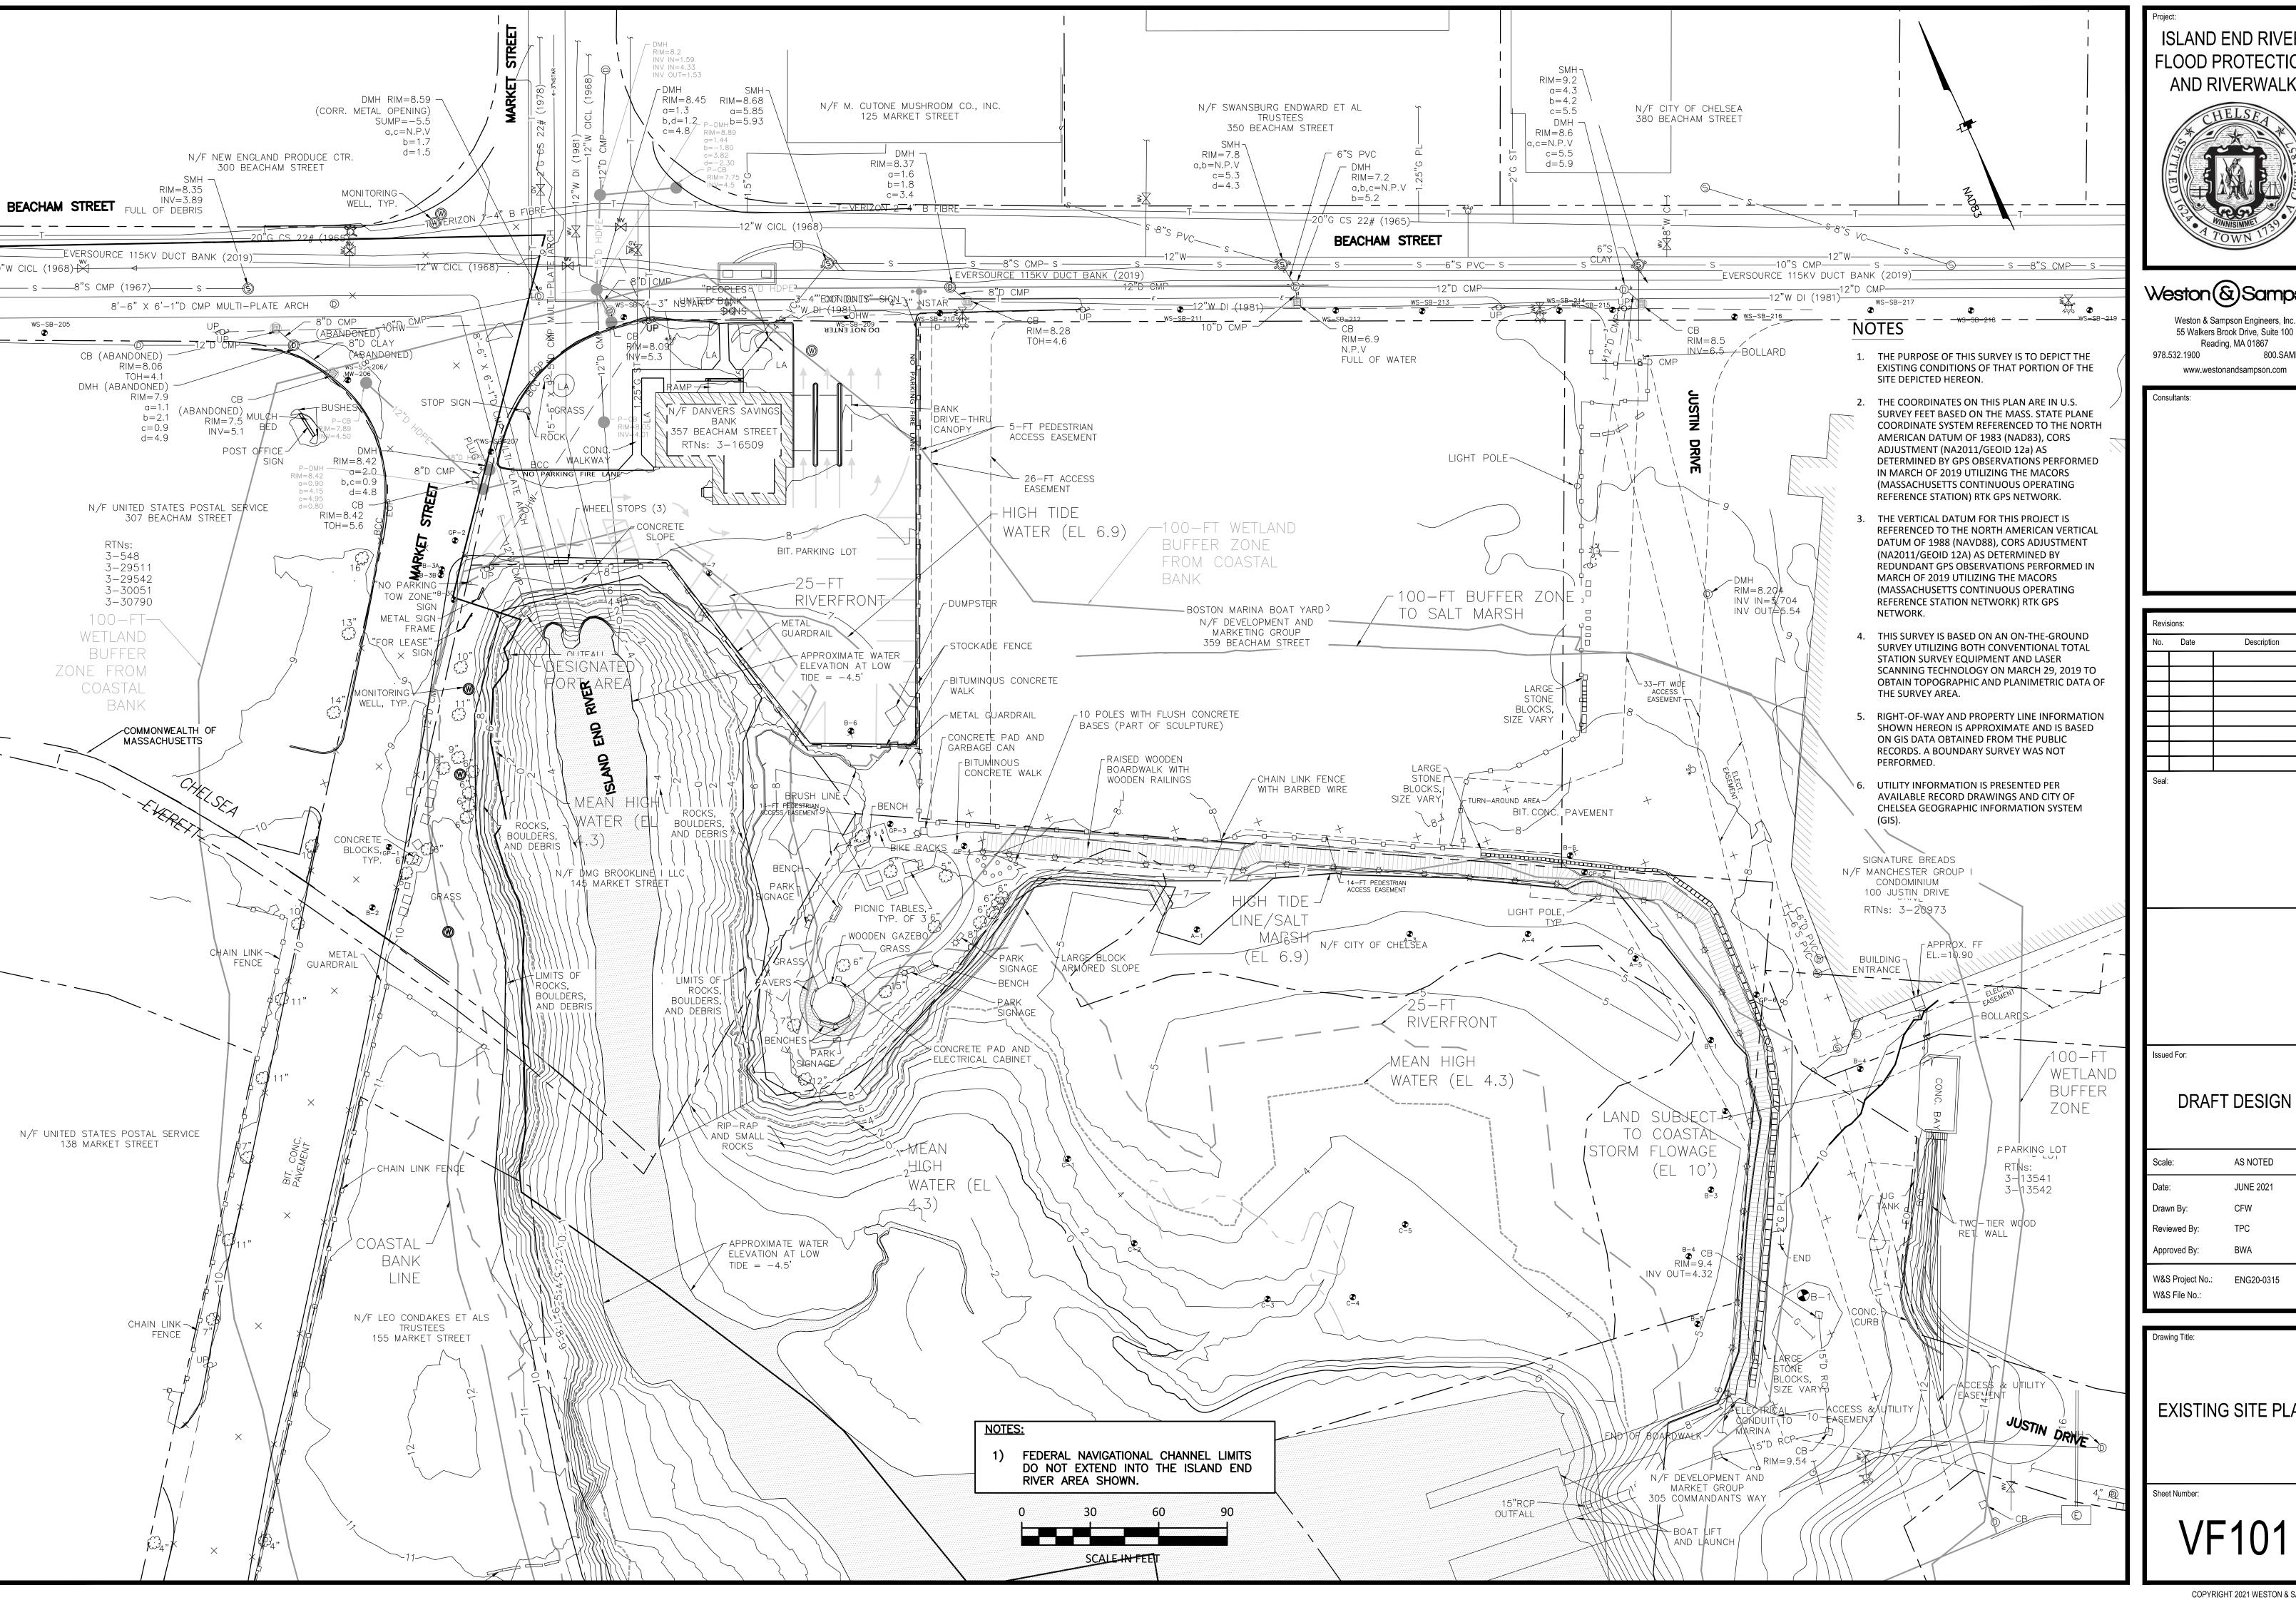

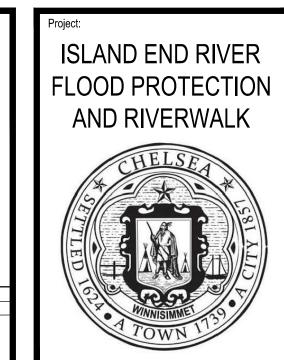


Weston & Sampson Engineers, Inc. 55 Walkers Brook Drive, Suite 100 Reading, MA 01867

No.	Date	Description
Seal:		

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AS NOTED JUNE 2021 CFW ENG20-0315

**EXISTING SITE PLAN** 

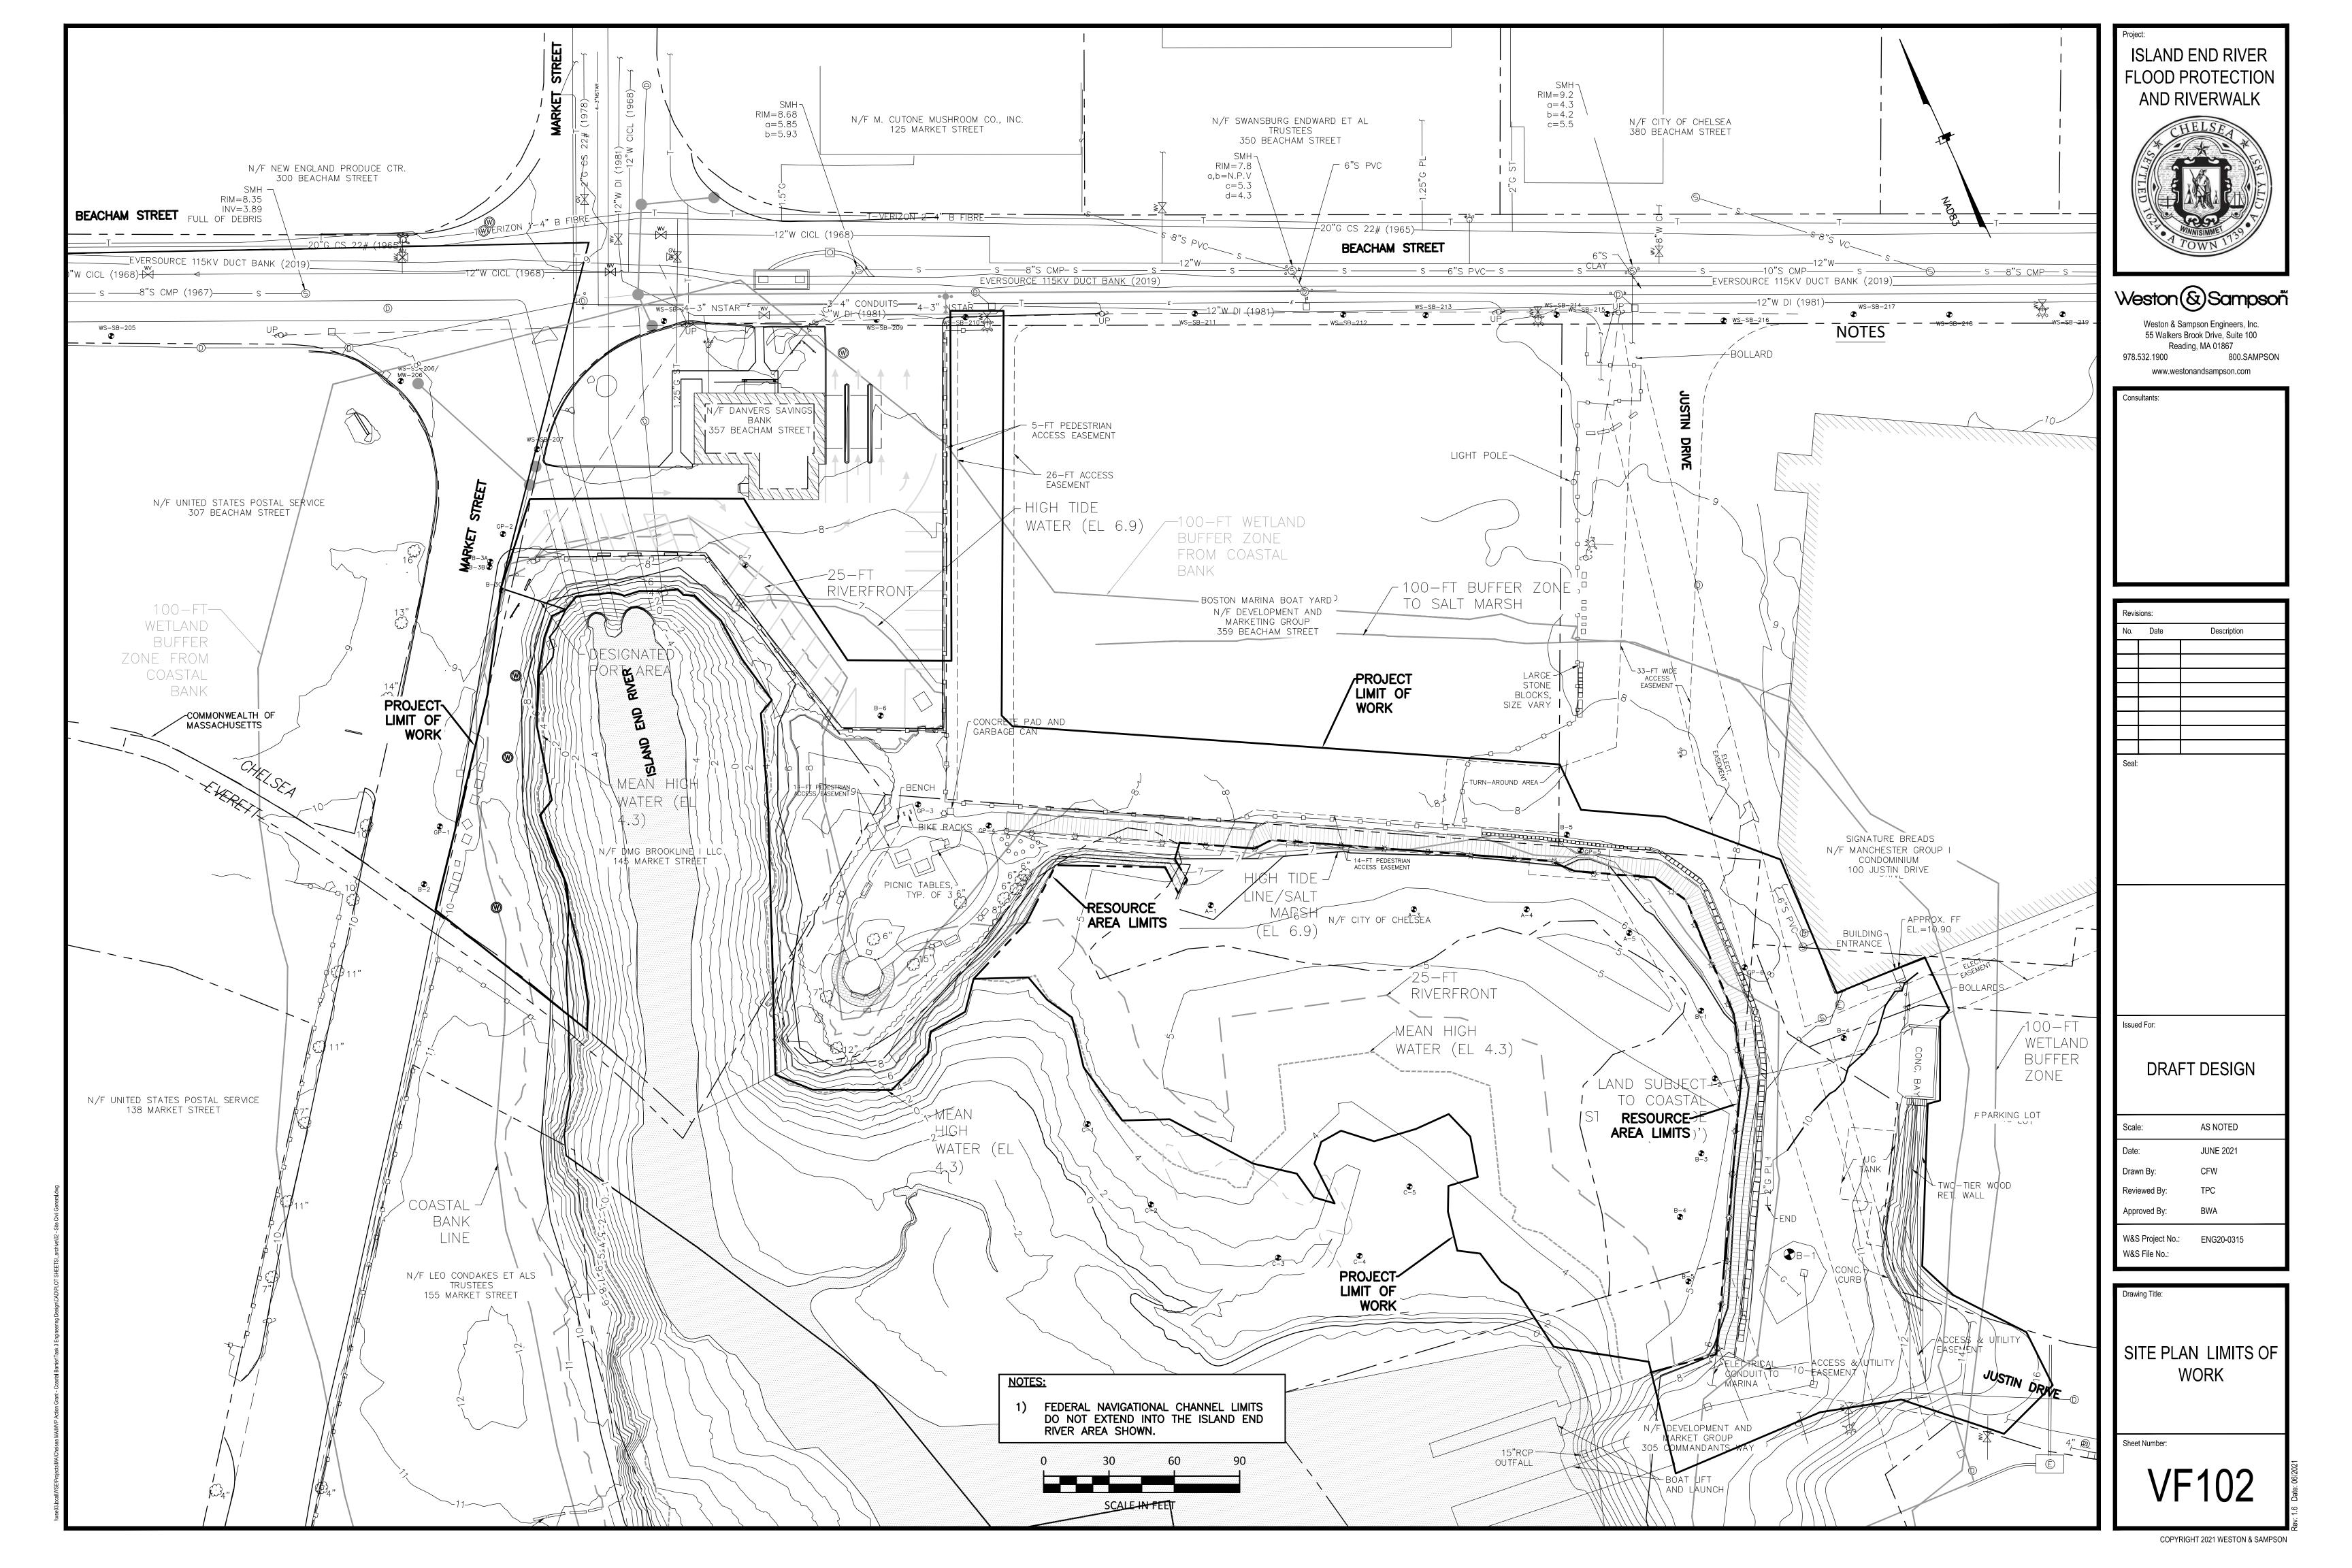

DESCRIPTION	EXISTING	PROPOSED
	EXISTING	PROPOSED
SANITARY SEWER	8"S VC	8"S PVC
FORCE MAIN	FM	— — 6"FM DI — —
WATER MAIN	_ 6"W_CI (1913)	6"W DI
VVATER WAIN		
TEMPORARY WATER		——4"TW——
STORM DRAIN	12"D RCP	15"D RCP
GAS	G	——4"G——
ELECTRIC	E	——E——
TELEPHONE	т	T
FRENCH DRAIN		
SANITARY SEWER MANHOLE	<b>S</b>	SMH
STORM DRAIN MANHOLE	O	DMH
ELECTRICAL MANHOLE	©	( EMH
TELEPHONE MANHOLE	©	( TMH
AIR RELEASE VALVE MANHOLE  FORCE MAIN CLEANOUT MANHOLE	© ©	FMCC
CLEANOUT CLEANOUT MANIFOLE	©	O CO
CATCH BASIN (WITH OR WITHOUT CURB INLET)	H	( <b>a</b> ) CB
<u>`</u>	GICB	DMHGI
GUTTER INLET, DI PIPE, & SUMP		
HYDRANT	**	<b>+</b>
TEMPORARY HYDRANT		Ф
GATE VALVE	wv 	н
CHECK VALVE	7	171
CURB STOP	450	*
BUTTERFLY VALVE	<u></u>	72
BALL VALVE	M	<b>₩</b>
REDUCER		◀
CAP OR PLUG	GV	]
UTILITY POLE	$\bowtie$	
GUY POLE	- <b>①</b>	-
LIGHT POST		
EDGE OF PAVEMENT	<b>*</b>	
EDGE OF UNPAVED ROAD		
CURB		<u> </u>
SIDEWALK		5
RAILROAD		
STONE WALL	~~~~~	~~~~~~
RETAINING WALL	RET WALL	RET WALL
FENCE	x_x_	XX
INDIVIDUAL DECIDUOUS TREE	<b>\( \tau \)</b>	
INDIVIDUAL EVERGREEN TREE	*	*
TREE LINE	~~~~	~~~~
WATER MANHOLE/MONITORING WELL	<u> </u>	
PROPERTY LINE	₽	
EASEMENT LINE		
LIMIT OF WORK		
APPROX. LIMIT OF REFUSE	x 141.5	x 141.5
SPOT ELEVATIONS CONTOUR LINES	56	— 56 —
N/F	NOW/FORMALLY	
HOUSE NUMBER	#35	
FLOOR ELEVATION	FL=56.7	
SILL ELEVATION	S=56.7	
WETLAND	_ <u>_</u>	
		<u></u> 1 · · <u>2</u>
WETLAND FLAGS		
RIP RAP	3688888	<u>\\\\\\\\\\\\\\\\\\\\\\\\\\\\\\\\\\\\\</u>
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RIP RAP		<u>*</u>
RIP RAP STATE HIGHWAY STATION	Δ	<u> </u>
RIP RAP STATE HIGHWAY STATION SURFACE MOUNTED DELINEATOR GUARD POST BOLLARD		<u>₩</u> ■  B
RIP RAP STATE HIGHWAY STATION SURFACE MOUNTED DELINEATOR GUARD POST BOLLARD SIGN	△ ○ B	<i>★</i>
RIP RAP STATE HIGHWAY STATION SURFACE MOUNTED DELINEATOR GUARD POST BOLLARD SIGN BENCH MARK	△ ○ B	
RIP RAP STATE HIGHWAY STATION SURFACE MOUNTED DELINEATOR GUARD POST BOLLARD SIGN BENCH MARK TIDE GATE CONCEPT	△ ○ B	
RIP RAP STATE HIGHWAY STATION SURFACE MOUNTED DELINEATOR GUARD POST BOLLARD SIGN BENCH MARK TIDE GATE CONCEPT COMPOST FILTER TUBE	△	<b>d</b>
RIP RAP STATE HIGHWAY STATION SURFACE MOUNTED DELINEATOR GUARD POST BOLLARD SIGN BENCH MARK TIDE GATE CONCEPT COMPOST FILTER TUBE TEST PIT	△	<b>d</b> TP-1
RIP RAP STATE HIGHWAY STATION  SURFACE MOUNTED DELINEATOR  GUARD POST  BOLLARD  SIGN  BENCH MARK  TIDE GATE CONCEPT  COMPOST FILTER TUBE  TEST PIT  BORING	Δ	<b>d</b> TP-1  B-11
RIP RAP STATE HIGHWAY STATION  SURFACE MOUNTED DELINEATOR  GUARD POST  BOLLARD  SIGN  BENCH MARK  TIDE GATE CONCEPT  COMPOST FILTER TUBE  TEST PIT  BORING  PROBE	△	<b>d</b> TP-1  B-11  P-11
RIP RAP STATE HIGHWAY STATION SURFACE MOUNTED DELINEATOR GUARD POST BOLLARD SIGN BENCH MARK TIDE GATE CONCEPT COMPOST FILTER TUBE TEST PIT BORING PROBE GROUNDWATER MONITORING WELL	△	<b>d</b> TP-1  B-11  P-11  WS-1
RIP RAP STATE HIGHWAY STATION SURFACE MOUNTED DELINEATOR GUARD POST BOLLARD SIGN BENCH MARK TIDE GATE CONCEPT COMPOST FILTER TUBE TEST PIT BORING PROBE GROUNDWATER MONITORING WELL GAS MONITORING WELL	△	d TP-1 ⊕ B-11 ⊕ P-11 ⊕ WS-1 ⊕ GMW-10
RIP RAP STATE HIGHWAY STATION  SURFACE MOUNTED DELINEATOR  GUARD POST  BOLLARD  SIGN  BENCH MARK  TIDE GATE CONCEPT  COMPOST FILTER TUBE  TEST PIT  BORING  PROBE  GROUNDWATER MONITORING WELL  GAS WONITORING WELL	△	<b>d</b> TP-1  B-11  P-11  WS-1
RIP RAP STATE HIGHWAY STATION SURFACE MOUNTED DELINEATOR GUARD POST BOLLARD SIGN BENCH MARK TIDE GATE CONCEPT COMPOST FILTER TUBE TEST PIT BORING PROBE GROUNDWATER MONITORING WELL GAS VENT FLAGGED FEATURE	△	d TP-1 ⊕ B-11 ⊕ P-11 ⊕ WS-1 ⊕ GMW-10
RIP RAP  STATE HIGHWAY STATION  SURFACE MOUNTED DELINEATOR  GUARD POST  BOLLARD  SIGN  BENCH MARK  TIDE GATE CONCEPT  COMPOST FILTER TUBE  TEST PIT  BORING  PROBE  GROUNDWATER MONITORING WELL  GAS WENT  FLAGGED FEATURE  ROCK OUTCROP	△	d TP-1 ⊕ B-11 ⊕ P-11 ⊕ WS-1 ⊕ GMW-10
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RIP RAP STATE HIGHWAY STATION SURFACE MOUNTED DELINEATOR GUARD POST BOLLARD SIGN BENCH MARK TIDE GATE CONCEPT COMPOST FILTER TUBE TEST PIT BORING PROBE GROUNDWATER MONITORING WELL GAS MONITORING WELL GAS VENT FLAGGED FEATURE ROCK OUTCROP DRAINAGE DITCH / SWALE 25-FT RIVERFRONT	△	d
RIP RAP STATE HIGHWAY STATION SURFACE MOUNTED DELINEATOR GUARD POST BOLLARD SIGN BENCH MARK TIDE GATE CONCEPT COMPOST FILTER TUBE TEST PIT BORING PROBE GROUNDWATER MONITORING WELL GAS WONITORING WELL GAS VENT FLAGGED FEATURE ROCK OUTCROP DRAINAGE DITCH / SWALE 25-FT RIVERFRONT MEAN HIGH TIDE	△	<b>d</b> TP-1  B-11  P-11  WS-1  GMW-10
RIP RAP  STATE HIGHWAY STATION  SURFACE MOUNTED DELINEATOR  GUARD POST  BOLLARD  SIGN  BENCH MARK  TIDE GATE CONCEPT  COMPOST FILTER TUBE  TEST PIT  BORING  PROBE  GROUNDWATER MONITORING WELL  GAS MONITORING WELL  GAS VENT  FLAGGED FEATURE  ROCK OUTCROP  DRAINAGE DITCH / SWALE  25-FT RIVERFRONT	△	<b>d</b> TP-1  B-11  P-11  WS-1  GMW-10

#### **GENERAL NOTES**

- REFER TO EXISTING CONDITIONS FOR SURVEY LEGEND. ALL BIDDERS ARE REQUIRED TO INSPECT THE PROJECT SITE IN ITS ENTIRETY PRIOR TO SUBMITTING THEIR BID, AND BECOME FAMILIAR WITH ALL CONDITIONS AS THEY MAY AFFECT THEIR BID. CONTRACTOR AND SUB-CONTRACTOR SHALL BE FAMILIAR WITH ALL DRAWINGS AND SPECIFICATIONS PRIOR TO COMMENCING THE CONSTRUCTION.
- 2. LOCATIONS OF ANY UTILITIES SHOWN ON THESE PLANS ARE APPROXIMATE ONLY. CONTRACTOR SHALL BE RESPONSIBLE FOR VERIFYING THE LOCATION OF SUCH UTILITIES, PROTECTING ALL EXISTING UTILITIES AND REPAIRING ANY DAMAGE DONE DURING CONSTRUCTION. THE CONTRACTOR SHALL BE RESPONSIBLE FOR ALL ON-SITE COORDINATION WITH UTILITY COMPANIES AND PUBLIC AGENCIES AND FOR OBTAINING ALL REQUIRED PERMITS AND PAYING ALL REQUIRED FEES. IN ACCORDANCE WITH M.G.L. CHAPTER 82, SECTION 40, INCLUDING AMENDMENTS, CONTRACTORS SHALL NOTIFY ALL UTILITY COMPANIES AND GOVERNMENT AGENCIES IN WRITING PRIOR TO EXCAVATION. CONTRACTOR SHALL ALSO CALL "DIG SAFE" AT (888) 344-7233 NO LESS THAN 72 HOURS, (EXCLUSIVE OF WEEKENDS AND HOLIDAYS), PRIOR TO SUCH EXCAVATION. DOCUMENTATION OF REQUESTS SHALL BE PROVIDED TO PROJECT REPRESENTATIVE PRIOR TO EXCAVATION WORK.
- CONTRACTOR SHALL BE RESPONSIBLE FOR REVIEWING ALL DRAWINGS AND SPECIFICATIONS TO DETERMINE THE EXTENT OF EXCAVATION AND DEMOLITION REQUIRED TO RECEIVE SITE IMPROVEMENTS.
- 4. ANY DISCREPANCIES OR CONFLICTS BETWEEN THE DRAWINGS AND EXISTING CONDITIONS, EXISTING CONDITIONS TO REMAIN, TEMPORARY CONSTRUCTION, PERMANENT CONSTRUCTION AND WORK OF ADJACENT CONTRACTS SHALL BE BROUGHT TO THE ATTENTION OF THE OWNER BEFORE PROCEEDING. ITEMS ENCOUNTERED IN AREAS OF EXCAVATION THAT ARE NOT INDICATED ON THE DRAWINGS, BUT ARE VISIBLE ON SURFACE, SHALL BE THE CONTRACTOR'S RESPONSIBILITY AND SHALL BE REMOVED AT NO ADDITIONAL COST TO THE OWNER.
- 5. ANY ALTERATIONS TO THESE DRAWINGS MADE IN THE FIELD DURING CONSTRUCTION SHALL BE RECORDED BY THE GENERAL CONTRACTOR ON "AS-BUILT" DRAWINGS.
- 6. ALL AREAS DISTURBED BY THE CONTRACTOR'S OPERATIONS OUTSIDE THE PROJECT TERMINI, SHALL BE RESTORED TO THE ORIGINAL CONDITION BY THE CONTRACTOR AT NO ADDITIONAL COST AND TO THE SATISFACTION OF THE OWNER.
- 7. THE CONTRACTOR SHALL TAKE ALL NECESSARY PRECAUTIONS TO PROTECT HIS EMPLOYEES, AS WELL AS PUBLIC USERS FROM INJURY DURING THE ENTIRE CONSTRUCTION PERIOD USING ALL NECESSARY SAFEGUARDS, INCLUDING BUT NOT LIMITED TO, THE ERECTION OF TEMPORARY WALKS, STRUCTURES, PROTECTIVE BARRIERS, COVERING, OR FENCES AS NEEDED.
- 8. THE CONTRACTOR SHALL SUPPLY THE OWNER WITH THE NAME OF THE OSHA "COMPETENT PERSON" PRIOR TO CONSTRUCTION.
- 9. FILLING OF EXCAVATED AREAS SHALL NOT TAKE PLACE WITHOUT THE PRESENCE OR PERMISSION OF THE OWNER.
- 10. EXISTING TREES TO REMAIN SHALL BE PROTECTED FROM CONSTRUCTION ACTIVITIES. NO STOCKPILING OF MATERIAL, EQUIPMENT OR VEHICULAR TRAFFIC SHALL BE ALLOWED WITHIN THE DRIP LINE OF TREES TO REMAIN. NO GUYS SHALL BE ATTACHED TO ANY TREE TO REMAIN. WHEN NECESSARY OR AS DIRECTED BY THE ENGINEER, THE CONTRACTOR SHALL ERECT TEMPORARY BARRIERS FOR THE PROTECTION OF EXISTING TREES DURING CONSTRUCTION.
- 11. NO FILLING SHALL OCCUR AROUND EXISTING TREES TO REMAIN WITHOUT THE APPROVAL OF THE OWNER OR OWNER REPRESENTATIVE.
- 12. ANY QUANTITIES SHOWN ON PLANS ARE FOR COMPARATIVE BIDDING PURPOSES ONLY. IT IS THE CONTRACTOR'S RESPONSIBILITY TO VISIT THE PROJECT SITE TO VERIFY ALL QUANTITIES AND CONDITIONS PRIOR TO SUBMITTING BID.
- 13. ALL EXISTING DRAINAGE FACILITIES TO REMAIN SHALL BE MAINTAINED FREE OF DEBRIS, SOIL, SEDIMENT, AND FOREIGN MATERIAL AND OPERATIONAL THROUGHOUT THE LIFE OF THE CONTRACT. REMOVE ALL SOIL, SEDIMENT, DEBRIS AND FOREIGN MATERIAL FROM ALL DRAINAGE STRUCTURES, INCLUDING BUT NOT LIMITED TO, DRAINAGE INLETS, MANHOLES AND CATCH BASINS WITHIN THE LIMIT OF WORK AND DRAINAGE STRUCTURES OUTSIDE THE LIMIT OF WORK THAT ARE IMPACTED BY THE WORK FOR THE ENTIRE DURATION OF CONSTRUCTION.
- 14. CONTRACTOR'S STAGING AREA MUST BE WITHIN THE CONTRACT LIMIT LINE AND IN AREAS APPROVED BY OWNER. ANY OTHER AREAS THAT THE CONTRACTOR MAY WISH TO USE FOR STAGING MUST BE COORDINATED WITH THE OWNER.
- 15. THE CONTRACTOR SHALL BROOM AND CLEAN ALL STREETS, PARKING LOTS AND WALKS THAT ARE NOT RESTRICTED FROM PUBLIC USE DURING CONSTRUCTION AT ALL TIMES. THE CONTRACTOR SHALL USE ACCEPTABLE METHODS AND MATERIALS TO MAINTAIN ADEQUATE DUST CONTROL THROUGHOUT CONSTRUCTION.
- 16. CONTRACTOR SHALL COORDINATE ALL WORK WITH THE OWNER. NOTIFY THE CONSERVATION COMMISSION 48 HOURS PRIOR AND TO THE COMMENCEMENT OF ANY ACTIVITIES WITHIN DEP JURISDICTION. PER THE DEP ORDER OF CONDITIONS.

#### **EROSION AND SEDIMENT CONTROL NOTES**

- 1. ALL SEDIMENT AND EROSION CONTROL DEVICES SHALL BE PUT INTO PLACE PRIOR TO BEGINNING ANY CONSTRUCTION OR DEMOLITION. REFER TO PLAN FOR APPROXIMATE LOCATION OF EROSION AND SEDIMENT CONTROL. REFER TO SPECS AND DETAILS FOR TYPE OF EROSION AND SEDIMENT CONTROL.
- 2. THE CONTRACTOR SHALL BE RESPONSIBLE FOR THE CONTINUAL MAINTENANCE OF ALL CONTROL DEVICES THROUGHOUT THE DURATION OF THE PROJECT.
- 3. CONTRACTOR SHALL MEET ALL OF THE STATE OF MASSACHUSETTS D.E.P. AND THE CITY OF CHELSEA'S WETLAND ORDINANCE REGULATIONS FOR SEDIMENT AND EROSION CONTROL.
- 4. A PERSON SHALL BE DESIGNATED TO BE RESPONSIBLE TO MONITOR COMPLIANCE WITH THE ORDER OF CONDITIONS. NAME AND CONTACT INFORMATION SHALL BE PROVIDED TO THE OFFICE OF THE CONSERVATION COMMISSION PRIOR TO THE START OF ANY ACTIVITY.
- 4.1. PERIODIC INSPECTIONS SHALL OCCUR TO ENSURE EFFECTIVENESS OF CONTROLS. SEE ORDER OF CONDITIONS.
- 4.2. INSPECTIONS OF CONTROLS SHALL OCCUR AFTER ANY RAIN EVENT GREATER THAN .5" OR AFTER HEAVY SNOW MELT.
- 5. EXCAVATED MATERIAL STOCKPILED ON THE SITE SHALL BE SURROUNDED BY A RING OF UNBROKEN SEDIMENT AND EROSION CONTROL FENCE. THE LIMITS OF ALL GRADING AND DISTURBANCE SHALL BE KEPT TO A MINIMUM WITHIN THE APPROVED AREA OF CONSTRUCTION. ALL AREAS OUTSIDE OF THE LIMIT OF CONTRACT SHALL REMAIN TOTALLY UNDISTURBED UNLESS OTHERWISE APPROVED BY OWNER'S REPRESENTATIVE.
- 6. ALL CATCH BASINS AND DRAIN GRATES WITHIN LIMIT OF CONTRACT AND AS SHOWN IN THE DRAWINGS SHALL BE PROTECTED WITH SEDIMENT SACK DURING THE ENTIRE DURATION OF CONSTRUCTION.
- 7. EROSION CONTROL BARRIERS TO BE INSTALLED AT THE TOE OF SLOPES. SEE GRADING & DRAINAGE PLANS, NOTES, DETAILS AND SPECIFICATIONS.
- 8. ANY AREA OUTSIDE THE PROJECT LIMIT THAT IS DISTURBED SHALL BE RESTORED TO ITS ORIGINAL CONDITION AT NO COST TO THE OWNER.
- 9. THE CONTRACTOR SHALL PROVIDE DUST CONTROL FOR CONSTRUCTION OPERATIONS AS APPROVED BY OWNER.
- 10. ALL POINTS OF CONSTRUCTION EGRESS OR INGRESS SHALL BE MAINTAINED TO PREVENT TRACKING OR FLOWING OF SEDIMENT ONTO PUBLIC/PRIVATE ROADS.

#### DEMOLITION & SITE PREPARATION NOTES

- 1. THE CONTRACTOR SHALL INCLUDE IN THE BID THE COST OF REMOVING ANY EXISTING SITE FEATURES AND APPURTENANCES NECESSARY TO ACCOMPLISH THE CONSTRUCTION OF THE PROPOSED SITE IMPROVEMENTS. THE CONTRACTOR SHALL ALSO INCLUDE IN THE BID THE COST NECESSARY TO RESTORE SUCH ITEMS IF THEY ARE SCHEDULED TO REMAIN AS PART OF THE FINAL SITE IMPROVEMENTS. REFER TO PLANS TO DETERMINE EXCAVATION, DEMOLITION AND TO DETERMINE THE LOCATION OF THE PROPOSED SITE IMPROVEMENTS.
- 2. THE OWNER RESERVES THE RIGHT TO REVIEW ALL MATERIALS DESIGNATED FOR REMOVAL AND TO RETAIN OWNERSHIP OF SUCH MATERIALS. IF THE OWNER RETAINS ANY MATERIAL THE CONTRACTOR SHALL MAKE ARRANGEMENTS WITH THE OWNER TO HAVE THOSE MATERIALS REMOVED OFF SITE AT NO ADDITIONAL COST.
- 3. UNLESS SPECIFICALLY NOTED TO BE SAVED / STOCKPILED (R&S) OR REUSED / RELOCATED (R&R), ALL SITE FEATURES CALLED FOR REMOVAL (R&D/ REM) SHALL BE REMOVED WITH THEIR FOOTINGS, ATTACHMENTS, BASE MATERIAL, ETC. TO FULL DEPTH AND TRANSPORTED FROM THE SITE TO BE DISPOSED OF IN A LAWFUL MANNER AT AN ACCEPTABLE DISPOSAL SITE AND AT NO COST TO THE OWNER.
- 4. ALL EXISTING SITE FEATURES TO REMAIN SHALL BE PROTECTED THROUGHOUT THE CONSTRUCTION PERIOD. ANY FEATURES DAMAGED DURING CONSTRUCTION OPERATIONS SHALL BE REPAIRED OR REPLACED TO THE SATISFACTION OF THE OWNER'S REPRESENTATIVE AT NO ADDITIONAL COST.
- 5. DURING EARTHWORK OPERATIONS, CONTRACTOR SHALL TAKE CARE TO NOT DISTURB EXISTING MATERIALS TO REMAIN, OUTSIDE THE LIMITS OF EXCAVATION AND BACKFILL AND SHALL TAKE WHATEVER MEASURES NECESSARY, AT THE CONTRACTOR'S EXPENSE, TO PREVENT ANY EXCAVATED MATERIAL FROM COLLAPSING. ALL BACKFILL MATERIALS SHALL BE PLACED AND COMPACTED AS SPECIFIED TO THE SUBGRADE REQUIRED FOR THE INSTALLATION OF THE REMAINDER OF THE CONTRACT WORK.
- 6. IT SHALL BE THE CONTRACTOR'S OPTION, WITH CONCURRENCE OF THE OWNER, TO REUSE EXISTING GRAVEL PAVEMENT BASE COURSE IF IT IS TESTED TO MEET THE REQUIREMENTS OF THE SPECIFICATIONS FOR GRAVEL BORROW.
- 7. 'CLEAR AND GRUB VEGETATION' INDICATED ON PLAN SHALL INCLUDE REMOVAL OF SHRUBS AND UNDERBRUSH, REMOVAL OF ROOTS, ROUGH GRADING, INSTALLATION OF LOAM (IF APPLICABLE), FINE GRADING, SEEDING AND TURF ESTABLISHMENT BY THE CONTRACTOR.
- 8. "STRIP & STORE OR SKIM & STOCKPILE" EXISTING TOPSOIL FOR LATER REUSE WHERE APPROPRIATE, AND AS NOTED ON PLAN, WITH APPROPRIATE EROSION AND SEDIMENT CONTROLS
- 9. LOAM / TOPSOIL DESIGNATED FOR REUSE AS GENERAL FILL SHALL BE BLENDED WITH SUITABLE BORROW MATERIAL AS SPECIFIED.
- 10. TREES DESIGNATED FOR REMOVAL SHALL BE TAGGED BY CONTRACTOR AND APPROVED BY OWNER'S REPRESENTATIVE PRIOR TO COMMENCEMENT OF CONSTRUCTION.
- 11. THE CONTRACTOR SHALL PROTECT EXISTING TREES TO REMAIN. CONTRACTOR SHALL INSTALL TREE PROTECTION BARRIER AFTER CLEARING UNDERBRUSH AND TAKE DUE CARE TO PREVENT INJURY TO TREES DURING CLEARING OPERATIONS.
- 12. THE STORAGE OF MATERIALS AND EQUIPMENT WILL BE PERMITTED AT LOCATIONS DESIGNATED BY OWNER OR OWNER'S REPRESENTATIVE. PROTECTION OF STORED MATERIALS AND EQUIPMENT SHALL BE THE SOLE RESPONSIBILITY OF THE CONTRACTOR.

#### GRADING & DRAINAGE NOTES

- ALL WORK RELATING TO INSTALLATION, RENOVATION OR MODIFICATION OF WATER, DRAINAGE AND/OR SEWER SERVICES SHALL BE PERFORMED IN ACCORDANCE WITH THE STANDARDS OF THE CITY OF CHELSEA.
- 2. THE CONTRACTOR SHALL VERIFY ALL DIMENSIONS AND GRADES ON THE GROUND AND REPORT ANY DISCREPANCIES IMMEDIATELY TO THE OWNER.
- 3. ALL GRADING IS TO BE SMOOTH AND CONTINUOUS WHERE PROPOSED SURFACE MEETS EXISTING SURFACE, BLEND THE TWO PAVEMENTS AND ELIMINATE ROUGH SPOTS AND


ABRUPT GRADE CHANGES AND MEET LINE AND GRADE OF EXISTING CONDITIONS WITH

- 4. CONTRACTOR SHALL MAINTAIN POSITIVE DRAINAGE (1.5% MINIMUM) AWAY FROM ALL BUILDING FOUNDATIONS AND STRUCTURES.
- 5. CONTRACTOR SHALL ENSURE ALL AREAS ARE PROPERLY PITCHED TO DRAIN, WITH NO SURFACE WATER PONDING OR PUDDLING.
- 6. WALKWAYS SHALL MAINTAIN A CROSS PITCH OF NOT MORE THAN ONE AND A HALF (1.5%) PERCENT AND THE RUNNING SLOPE (PARALLEL TO THE DIRECTION OF TRAVEL) BETWEEN 1% MIN. AND 4.5% MAX. ALL NEW WALKWAYS / ACCESS PATHS MUST CONFORM TO CURRENT AMERICANS WITH DISABILITIES ACT (ADA) REGULATIONS: WALKWAYS SHALL MAINTAIN A CROSS PITCH OF NOT MORE THAN TWO (2%) PERCENT AND THE RUNNING SLOPE (PARALLEL TO THE DIRECTION OF TRAVEL) 5% MAX. ANY DISCREPANCIES NOT ALLOWING THIS TO OCCUR SHALL BE REPORTED TO THE OWNER PRIOR TO CONTINUING WORK. ANY PATHS/WALKS FOUND TO BE OUT OF COMPLIANCE SHALL BE REGRADED AND REPAVED AT NO COST TO THE OWNER.
- 7. ALL UTILITY GRATES, COVERS OR OTHER SURFACE ELEMENTS INTENDED TO BE EXPOSED AT GRADE SHALL BE FLUSH WITH THE ADJACENT FINISHED GRADE AND ADJUSTED TO PROVIDE A SMOOTH TRANSITION AT ALL EDGES.
- 8. THE CONTRACTOR SHALL SET SUBGRADE ELEVATIONS TO ALLOW FOR POSITIVE DRAINAGE AND PROVIDE EROSION CONTROL DEVICES, STRUCTURES, MATERIALS AND CONSTRUCTION METHODS TO DIRECT SILT MIGRATION AWAY FROM DRAINAGE AND OTHER UTILITY SYSTEMS, PUBLIC/PRIVATE STREETS AND WORK AREAS. CLEAN BASINS REGULARLY AND AT THE END OF THE PROJECT.
- 9. EXCAVATION REQUIRED WITHIN PROXIMITY OF KNOWN EXISTING UTILITY LINES SHALL BE DONE BY HAND. CONTRACTOR SHALL REPAIR ANY DAMAGE TO EXISTING UTILITY LINES OR STRUCTURES INCURRED DURING CONSTRUCTION OPERATIONS AT NO COST TO THE OWNER.
- 10. WHERE NEW EARTHWORK MEETS EXISTING EARTHWORK, CONTRACTOR SHALL BLEND NEW EARTHWORK SMOOTHLY INTO EXISTING, PROVIDING VERTICAL CURVES OR ROUNDS AT ALL TOP AND BOTTOM OF SLOPES.
- 11. WHERE A SPECIFIC LIMIT OF WORK LINE IS NOT OBVIOUS OR IMPLIED, BLEND GRADES TO EXISTING CONDITIONS WITHIN 5 FEET OF PROPOSED CONTOURS.
- 12. RESTORE ALL DISTURBED AREAS AND LIMITS OF ALL REMOVALS TO LOAM AND SEED (L&S) UNLESS OTHERWISE NOTED.
- SEE EARTHWORK SECTION OF SPECIFICATIONS FOR SPECIFIC EXCAVATION AND FILLING PROCEDURES.

#### LAYOUT & MATERIALS NOTES


- 1. REFER TO EXISTING CONDITIONS PLANS FOR SURVEY INFORMATION (SHEET VF101).
- COORDINATE ALL LAYOUT ACTIVITIES WITH THE SCOPE OF WORK CALLED FOR BY DEMOLITION, GRADING AND UTILITIES OPERATIONS ENCOMPASSED BY THIS CONTRACT. SET, PROTECT AND REPLACE REFERENCE STAKES AS NECESSARY OR AS REQUIRED BY THE OWNER'S REPRESENTATIVE.
- 3. ALL WORK SHALL BE PERFORMED BY CONTRACTOR UNLESS SPECIFICALLY INDICATED THAT THE WORK WILL BE PERFORMED "BY CITY".
- 4. TO FACILITATE LAYOUT OF PROPOSED SITE FEATURES AND FACILITIES, LAYOUT INFORMATION FOR CERTAIN FUTURE WORK, WHICH IS NOT INCLUDED WITHIN THE SCOPE OF THIS CONTRACT (E.G., FUTURE PHASE APPURTENANCES, PAVING, ETC.), HAS BEEN PROVIDED ON THE LAYOUT AND MATERIALS PLAN FOR INFORMATION ONLY.
- 5. THE LAYOUT OF SITE AMENITIES AND FENCES MUST BE APPROVED BY THE OWNER'S REPRESENTATIVE PRIOR TO INSTALLATION. SOME ITEMS MAY "NOT BE IN CONTRACT" AND SHOWN FOR LOCATION REFERENCE ONLY.
- 6. THE LAYOUT OF ALL NEW PATHWAYS / WALKWAYS AND THE GRADING OF ALL SLOPES AND CROSS SLOPES SHALL CONFORM TO THE COMMONWEALTH OF MASSACHUSETTS RULES AND REGULATIONS FOR HANDICAP ACCESS CMR 521, AND THE AMERICANS WITH DISABILITIES ACT (ADA), TITLE 3. THE CONTRACTOR SHALL NOTIFY THE OWNER IMMEDIATELY OF ANY DISCREPANCIES BETWEEN ACTUAL CONDITIONS AND THOSE REQUIRED.
- 7. ALL LAYOUT LINES, OFFSETS, OR REFERENCES TO LOCATING OBJECTS ARE EITHER PARALLEL OR PERPENDICULAR UNLESS OTHERWISE DESIGNATED WITH ANGLE OFFSETS
- 8. ALL PROPOSED SITE FEATURES SHALL BE LAID OUT AND STAKED FOR REVIEW AND APPROVAL BY THE OWNER'S REPRESENTATIVE PRIOR TO COMMENCEMENT OF INSTALLATION. ANY REQUIRED ADJUSTMENTS TO THE LAYOUT SHALL BE UNDERTAKEN AS DIRECTED, AT NO ADDITIONAL COST TO THE OWNER.
- 9. ALL PROPOSED PAVEMENTS SHALL MEET THE LINE AND GRADE OF EXISTING ADJACENT PAVEMENT SURFACES AND SHALL BE TREATED WITH AN RS-1 TACK COAT AT POINT OF CONNECTION. ALL PATHWAY WIDTHS SHALL BE AS NOTED ON THE LAYOUT AND MATERIALS BLAN
- 10. THE CONTRACTOR SHALL VERIFY ALL DIMENSIONS AND GRADES ON THE GROUND AND REPORT ANY DISCREPANCIES IMMEDIATELY TO THE OWNER.
- 11. THE CONTRACTOR SHALL BE RESPONSIBLE FOR FIELD MEASUREMENT OF ALL PROPOSED FENCES AND GATES.
- 12. THE DEPTH OF LOAM BORROW FOR ALL PROPOSED LAWN AREAS SHALL BE 4" MINIMUM. ALL DISTURBED AREAS SHALL BE RESTORED WITH LOAM AND SEED UNLESS OTHERWISE NOTED.
- 13. ALL REFERENCES TO LOAM AND SEED (L&S) REFER TO HYDROMULCH SEEDED LAWN.
- EXISTING PATHWAY GRAVEL MATERIALS SHALL BE REUSED WHENEVER POSSIBLE MAKING FIELD APPROVAL MANDATORY PER SPEC.
- 15. REFER TO DETAIL DRAWINGS FOR SITE CONSTRUCTION DETAILS.


#### LEGEND FOR WETLANDS RESTORATION

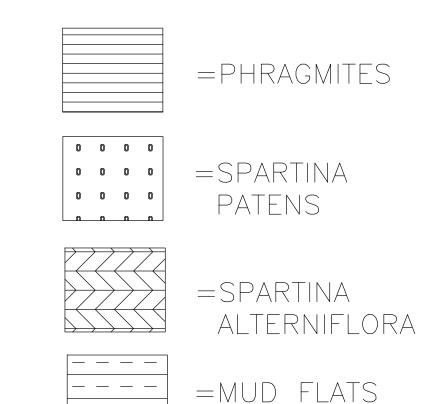

#### LEGEND FOR STRUCTURAL

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Date: JUNE 2021

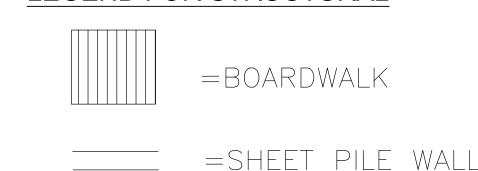Drawn By: CFW

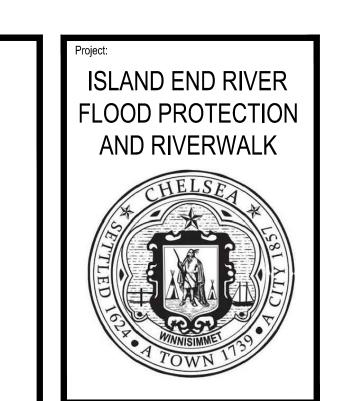Reviewed By: TPC

Approved By: BWA

W&S Project No.: ENG20-0315


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CIVIL/SITE GENERAL

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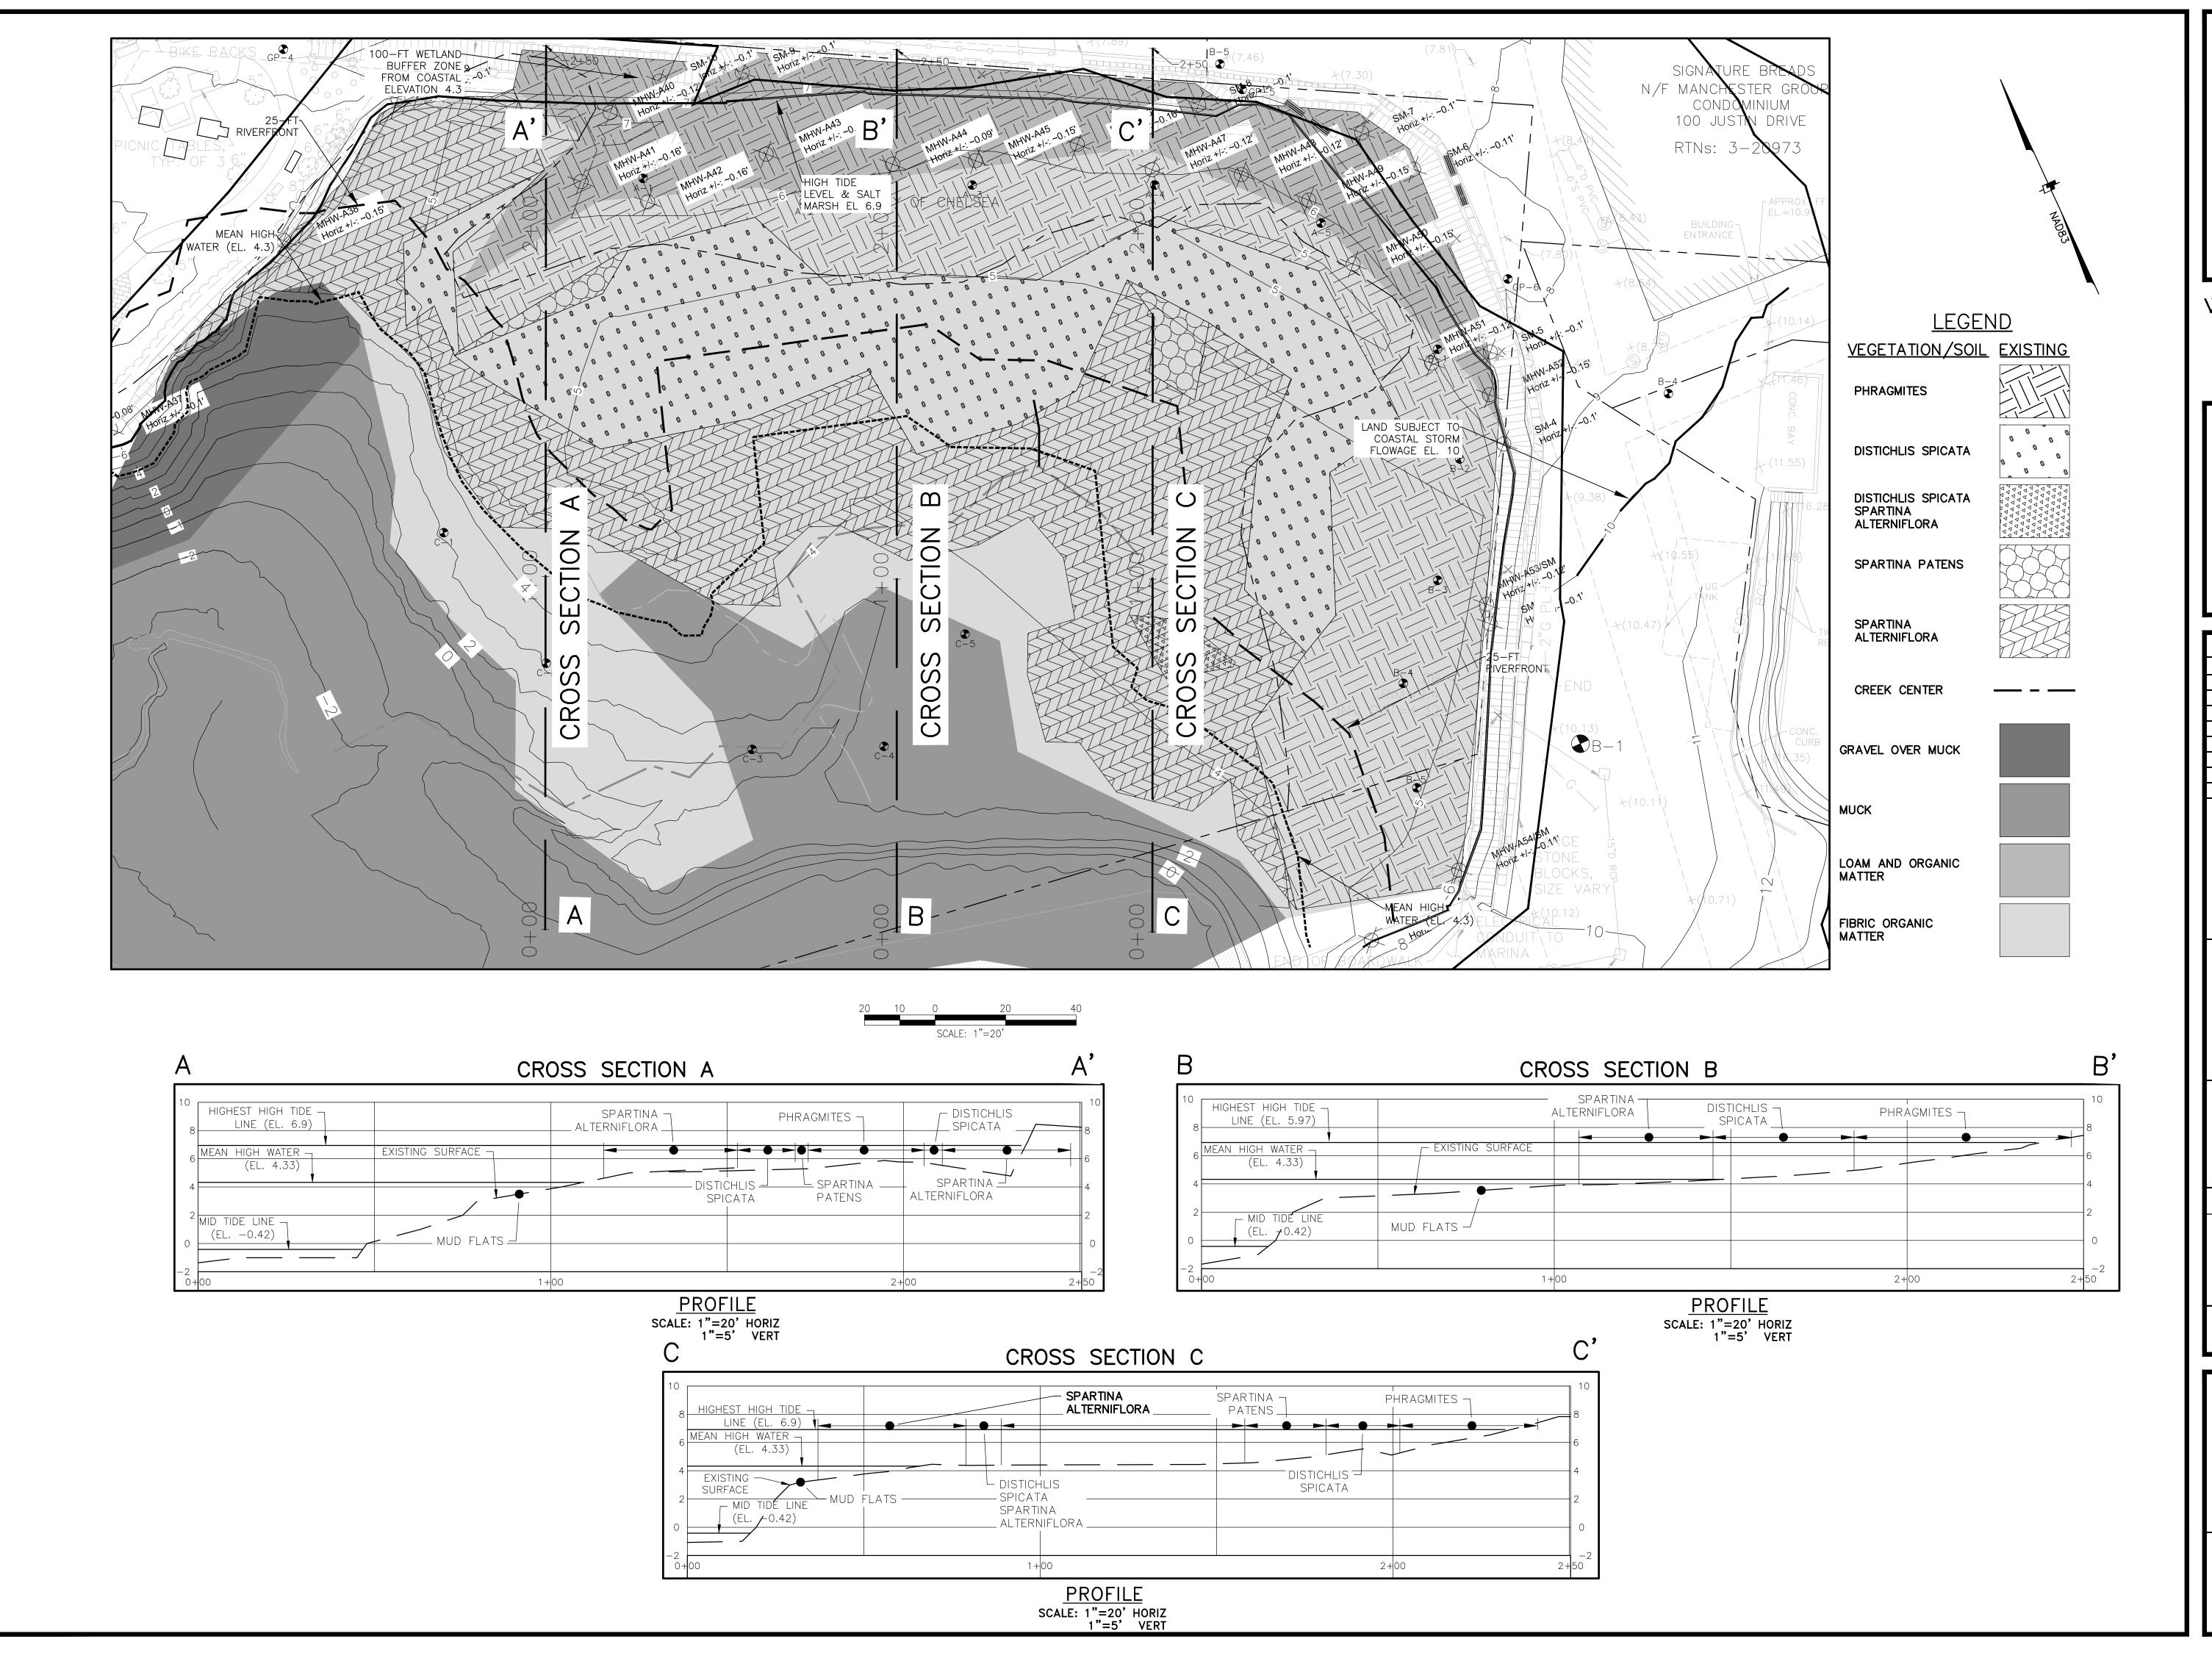



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**EROSION AND** SEDIMENT CONTROL



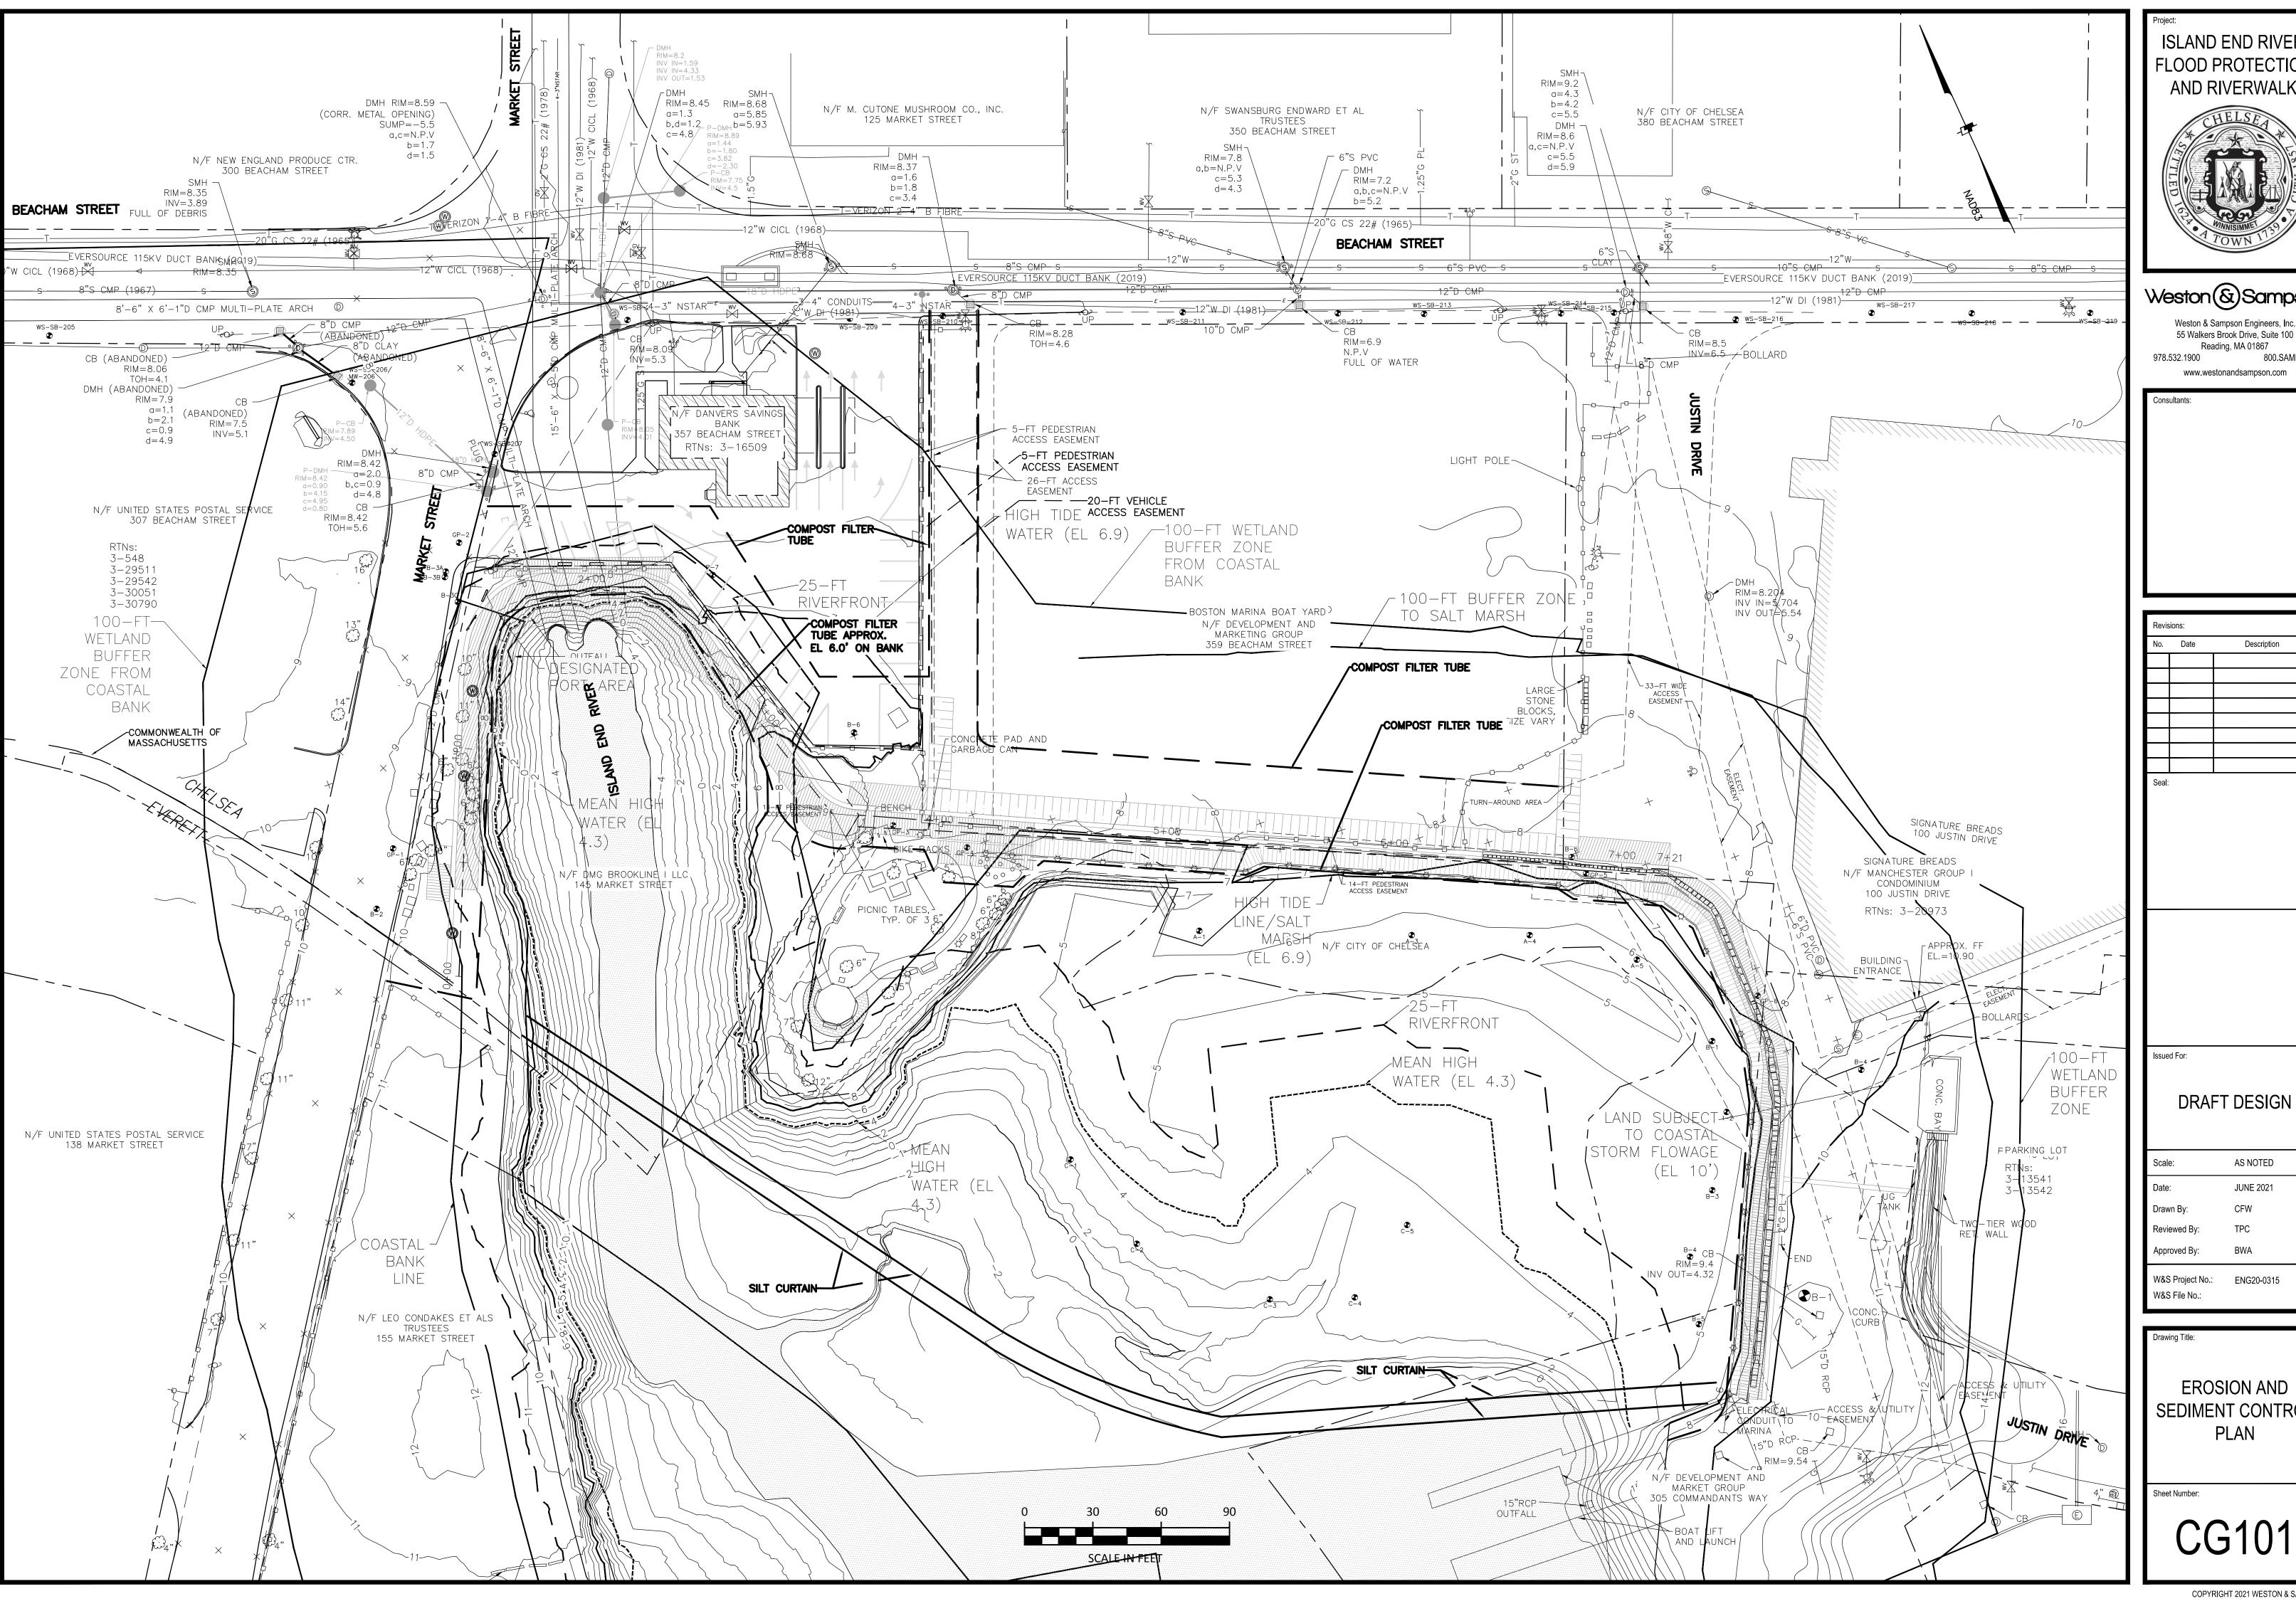

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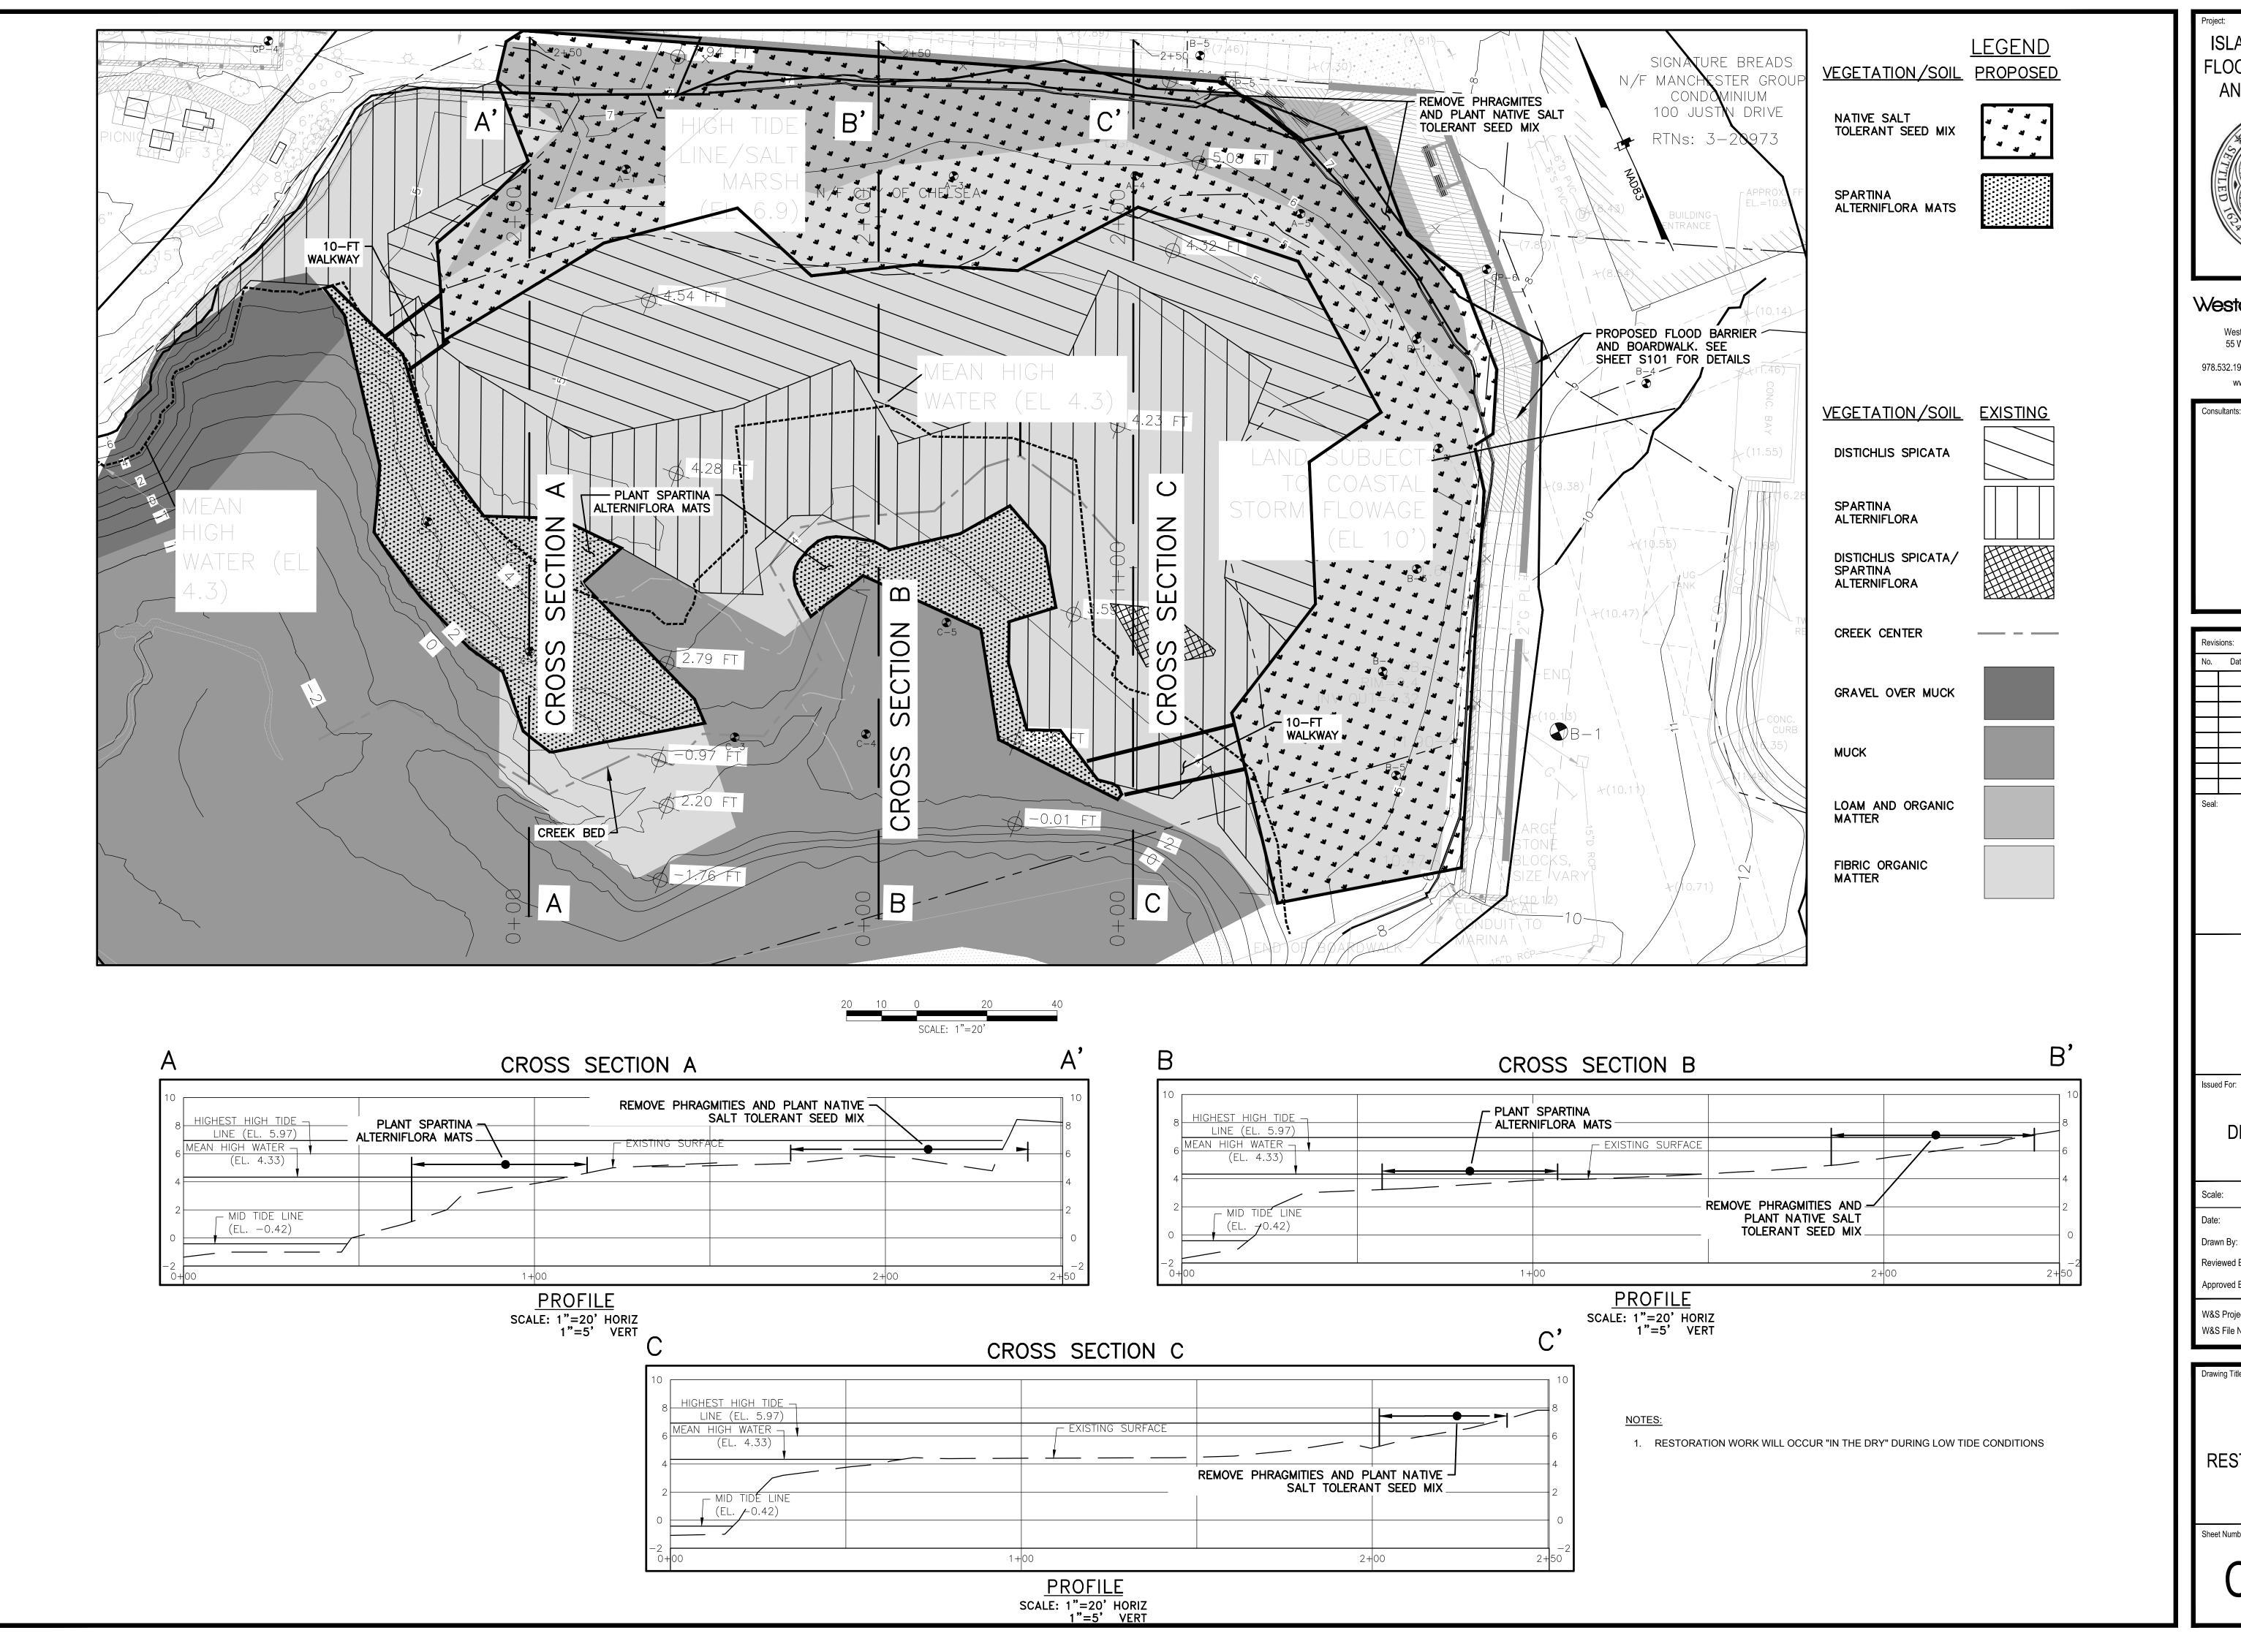
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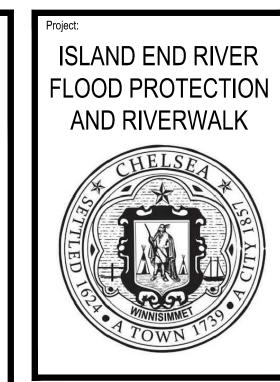
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WETLANDS EXISTING CONDITIONS PLAN


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WETLANDS RESTORATION PLAN
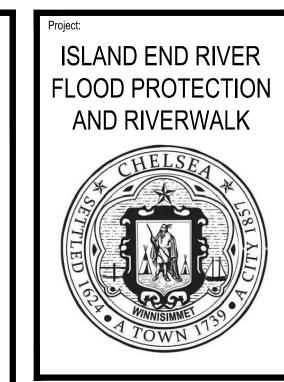
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CG103

EROSION CONTROLS - COMPOST FILTER TUBES

SCALE: N.T.S.

NOTE:

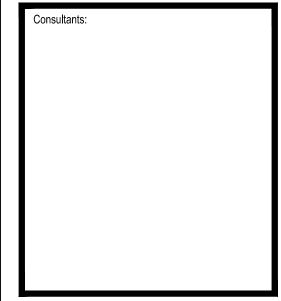
1. HAYBALE/SANDBAG PROTECTION OR CATCH BASIN FILTER FOR PAVED AREAS SHALL BE PROVIDED FOR ALL DRAINAGE STRUCTURES WITHIN THE LIMIT OF WORK AND ANY STRUCTURES
OUTSIDE THE PROJECT TERMINII THAT ARE AFFECTED BY 1" REBAR FOR BAG REMOVAL -FROM INLET (PROVIDE REBAR) OPTIONAL OVERFLOW - LOCATE STRAWBALES & WOOD STAKES AS SHOWN ON LAND APPROVED CATCH — BASIN FILTER DUMP LOOPS -- WRAP GRATE IN (PROVIDE REBAR) FILTER FABRIC EXPANSION RESTRAINT ----- LOCATE SAND BAGS AROUND INLETS AND COVER WITH FILTER FABRIC - TIE HAYBALES TOP AND LAY SANDBAGS TO -BOTTOM WITH 14 GAUGE WIRE ENSURE RESTRICTION FINISH GRADE OF DRAINAGE FLOW ELEVATION VIEW SIDE VIEW INSTALLED INSTALLATION ON DIFFERENT SURFACES

\_\_\_\_

INLET SEDIMENT CONTROL- CB PROTECTION SCALE: N.T.S.

SILT CURTAIN \_\_\_ TOP LOAD LINE — TOP LOAD LINE BUOY ¬ FLOATATION ¬ DEVICE - ANCHOR BUOY — WATER LEVEL WATER LEVEL — FLOATATION DEVICE CONNECTION ~ NYLON ROPE 🔪 SILT CURTAIN < GROMMETS ☐ ANCHOR DEVICE - BALLAST LINE (GALVANIZED CHAIN) (GALVANIZED CHAIN) GALVANIZED CHAIN BOTTOM SEDIMENT BOTTOM SEDIMENT SIDE VIEW N.T.S. SECTION VIEW N.T.S.


3 SILT CURTAIN SCALE: N.T.S.

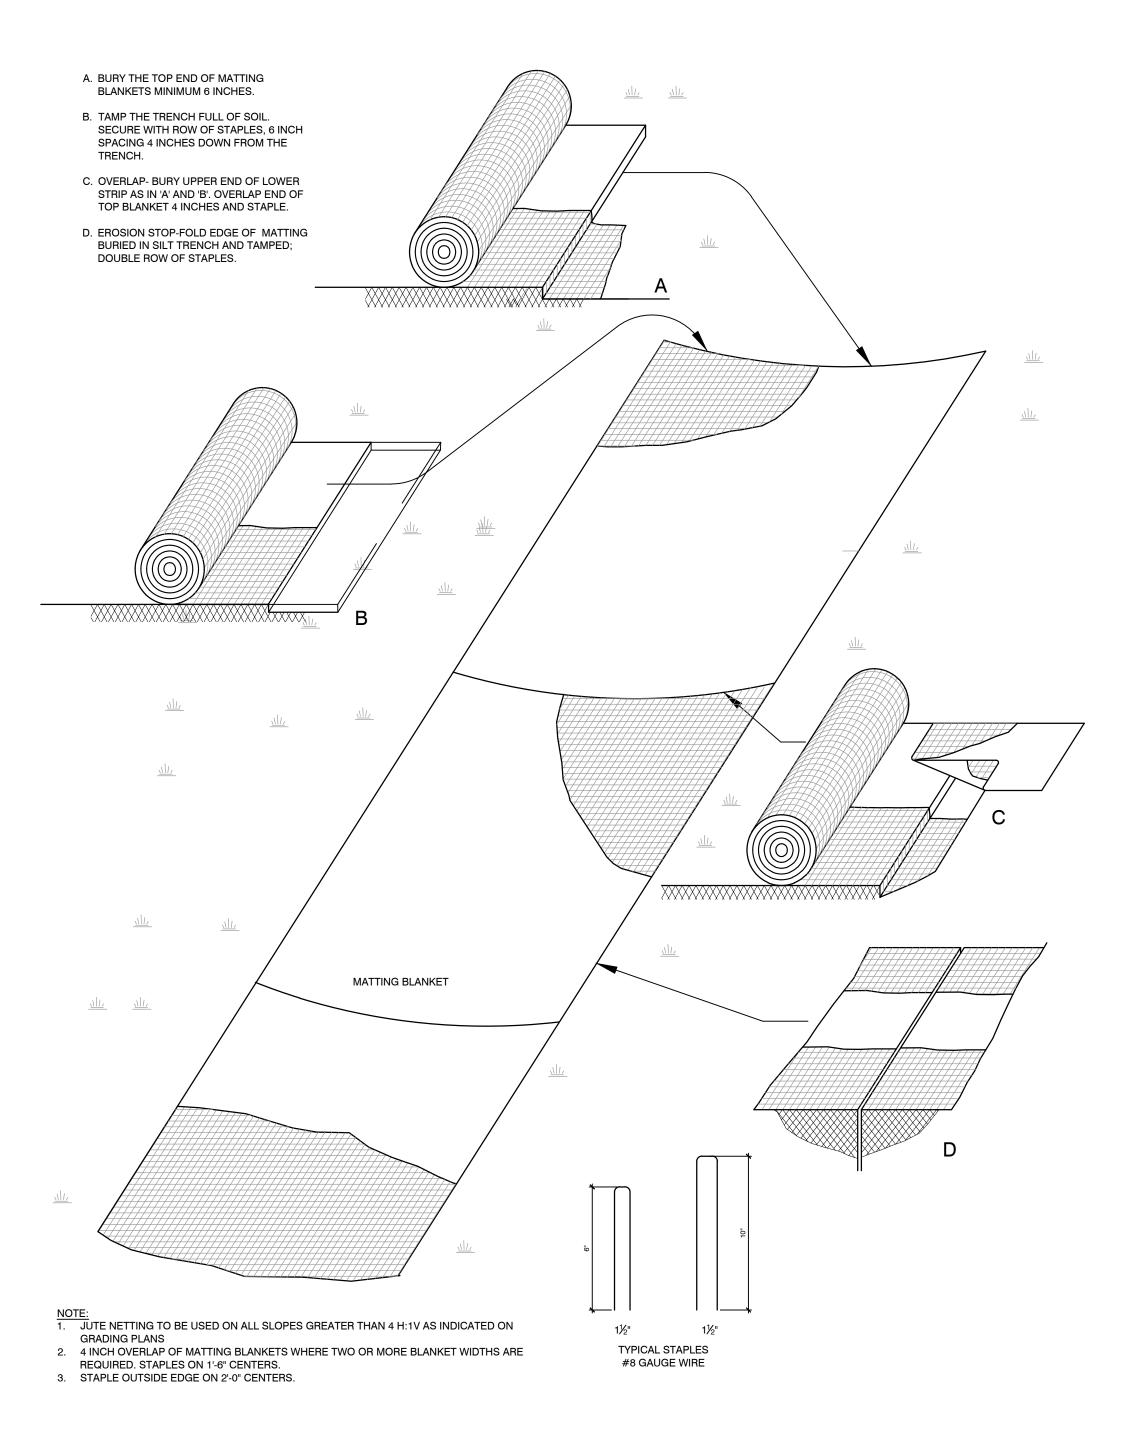




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**EROSION CONTROLS BLANKET** 

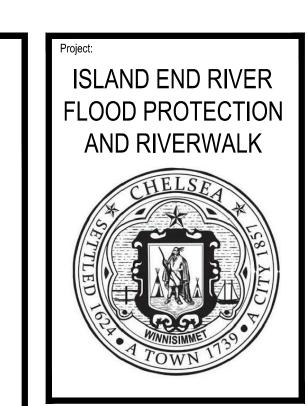

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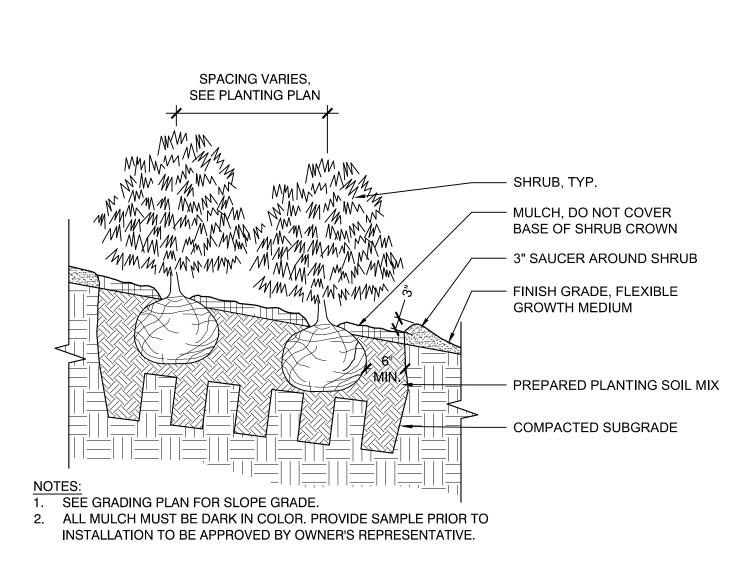
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CIVIL/SITE DETAILS

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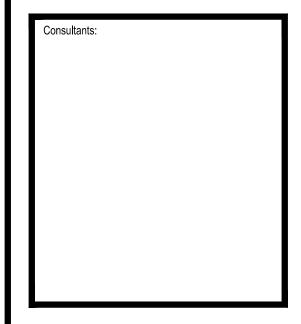


1 SHRUB PLANTING AT SLOPE

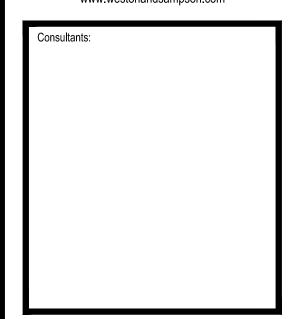ISLAND END RIVER FLOOD PROTECTION AND RIVERWALK

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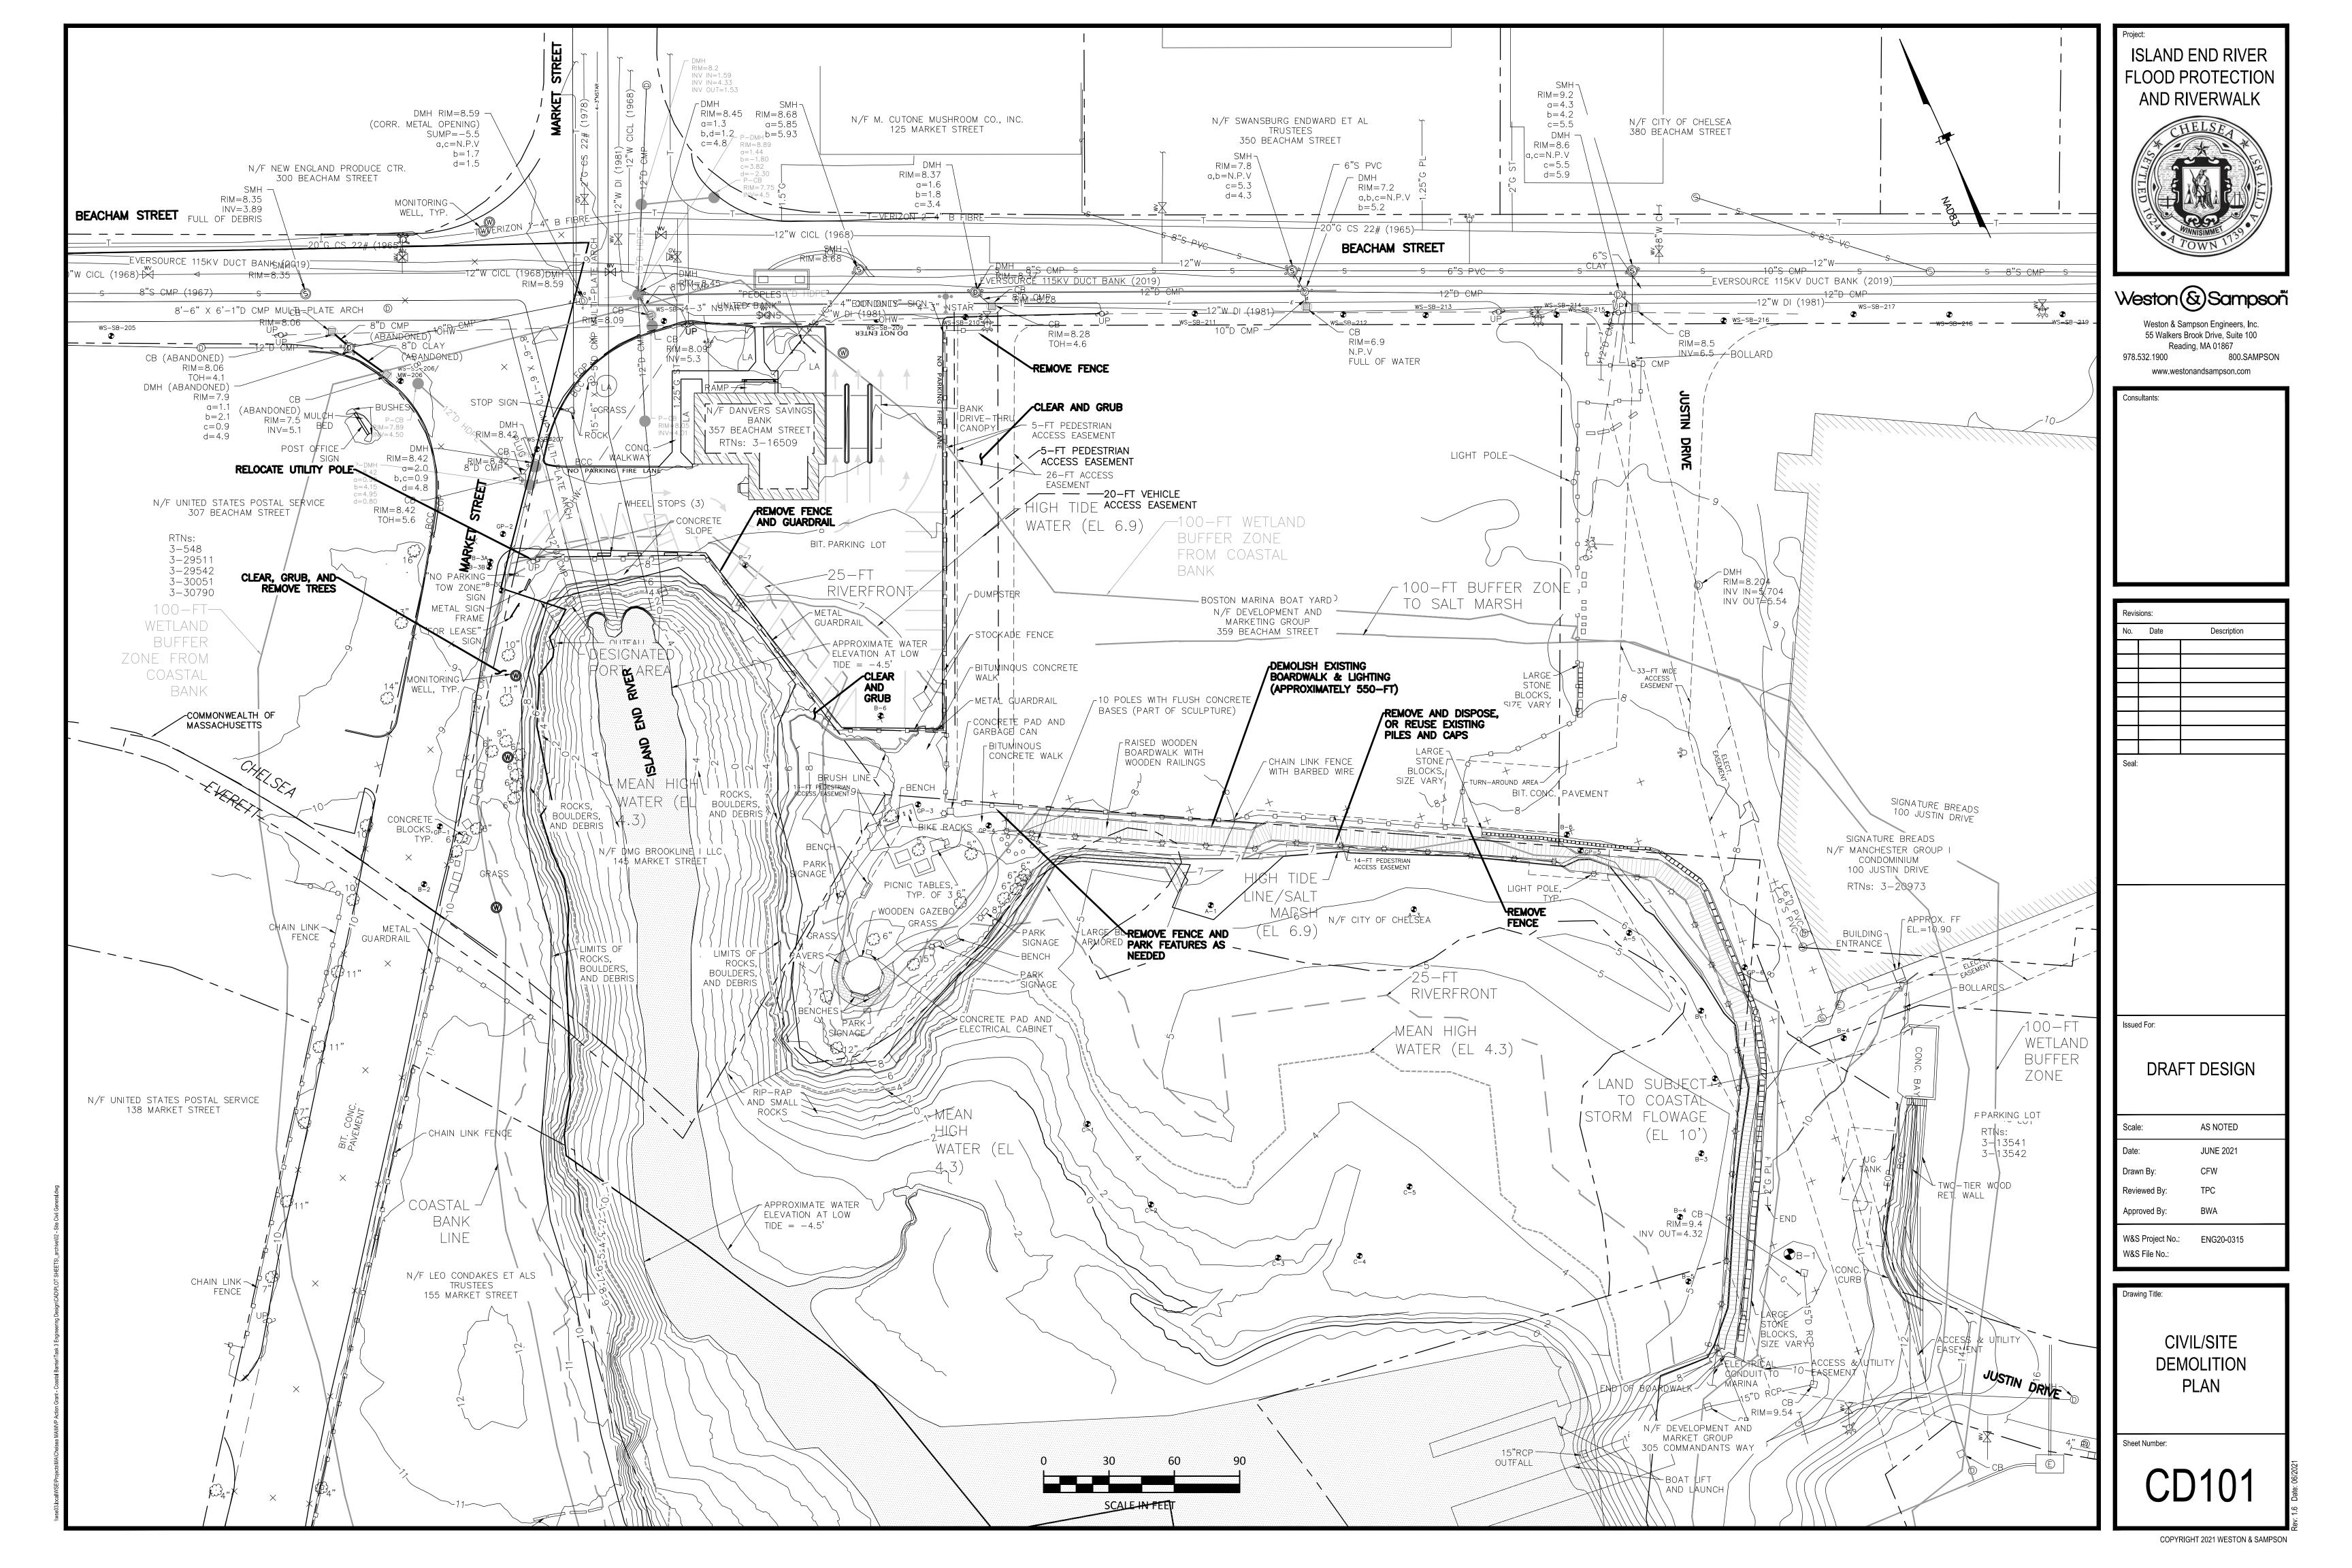
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	Approved By:	BWA
	W&S Project No.: W&S File No.:	ENG20-0315


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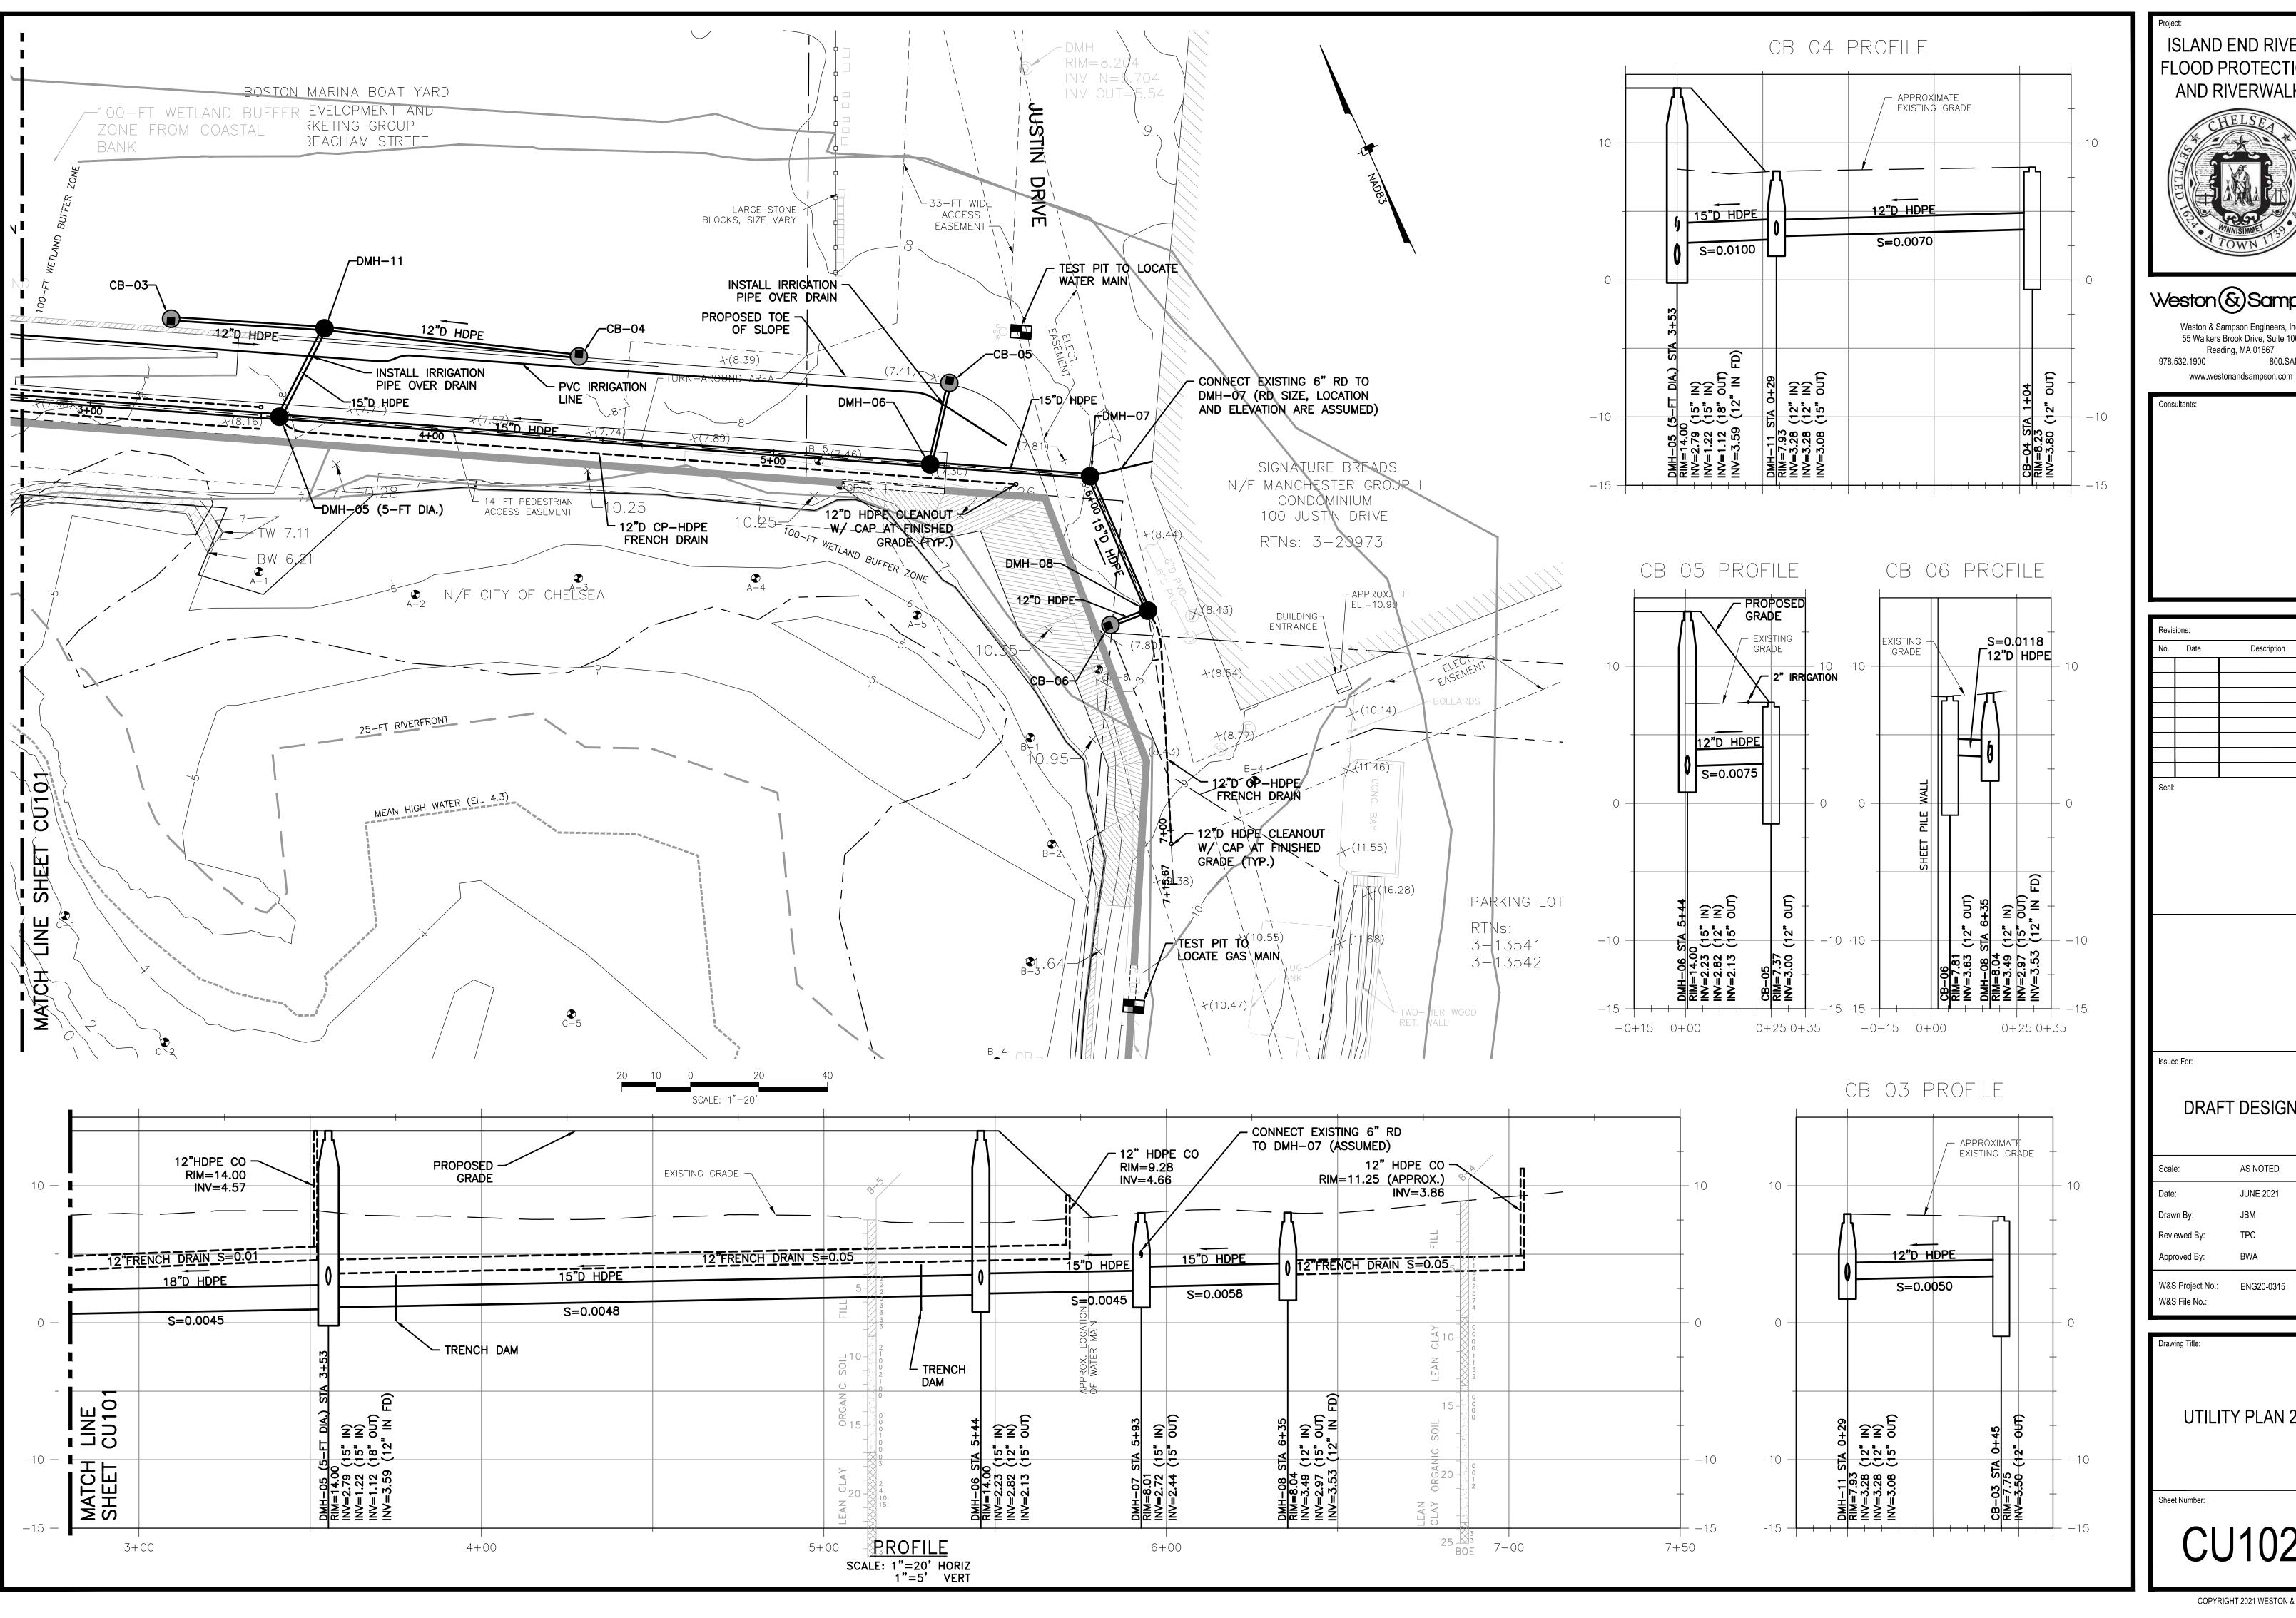
WETLANDS RESTORATION DETAILS

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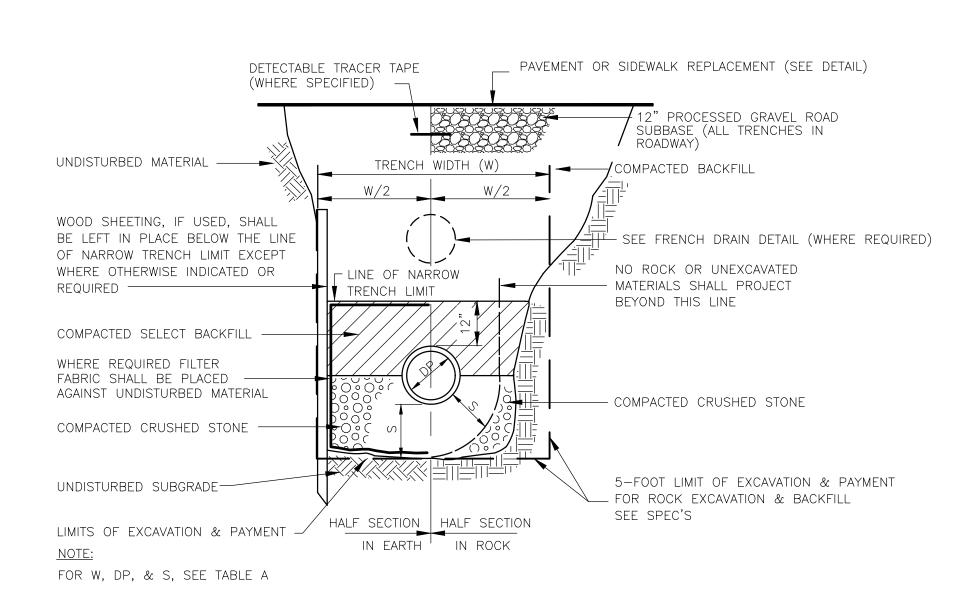
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UTILITY PLAN 2




ACTUAL TRENCH WIDT (2.0' PAYMENT LIMIT)			, FILTER IC OVERLAP
PAVEMENT REPLACEMENT (SEE DETAIL)	\		INCH DIAMETER CLEANOUT
GRAVEL ROADWAY SUBBASE		000000 000000 000000	18-INCH MIN. DEPTH
FILTER FABRIC		3000	6" MIN. ALL AROUND
	0000000 0000000 0000000000000000000000	200000 200000 2000000 2000000000000000	— 3/4" CRUSHED STONE  —— INSTALL UNDERDRAIN TO ELEVATION
			AS SPECIFIED IN DRAWINGS.  12" PERFORATED CORRUGATED POLYETHYLENE UNDERDRAIN PIPE
UNDISTURBED MATERIAL	LINS	TALL UNDERDI TED ON DRAW	RAIN WITH SLOPE AS INGS.

CLEANOUT WITH CAP AT FINAL

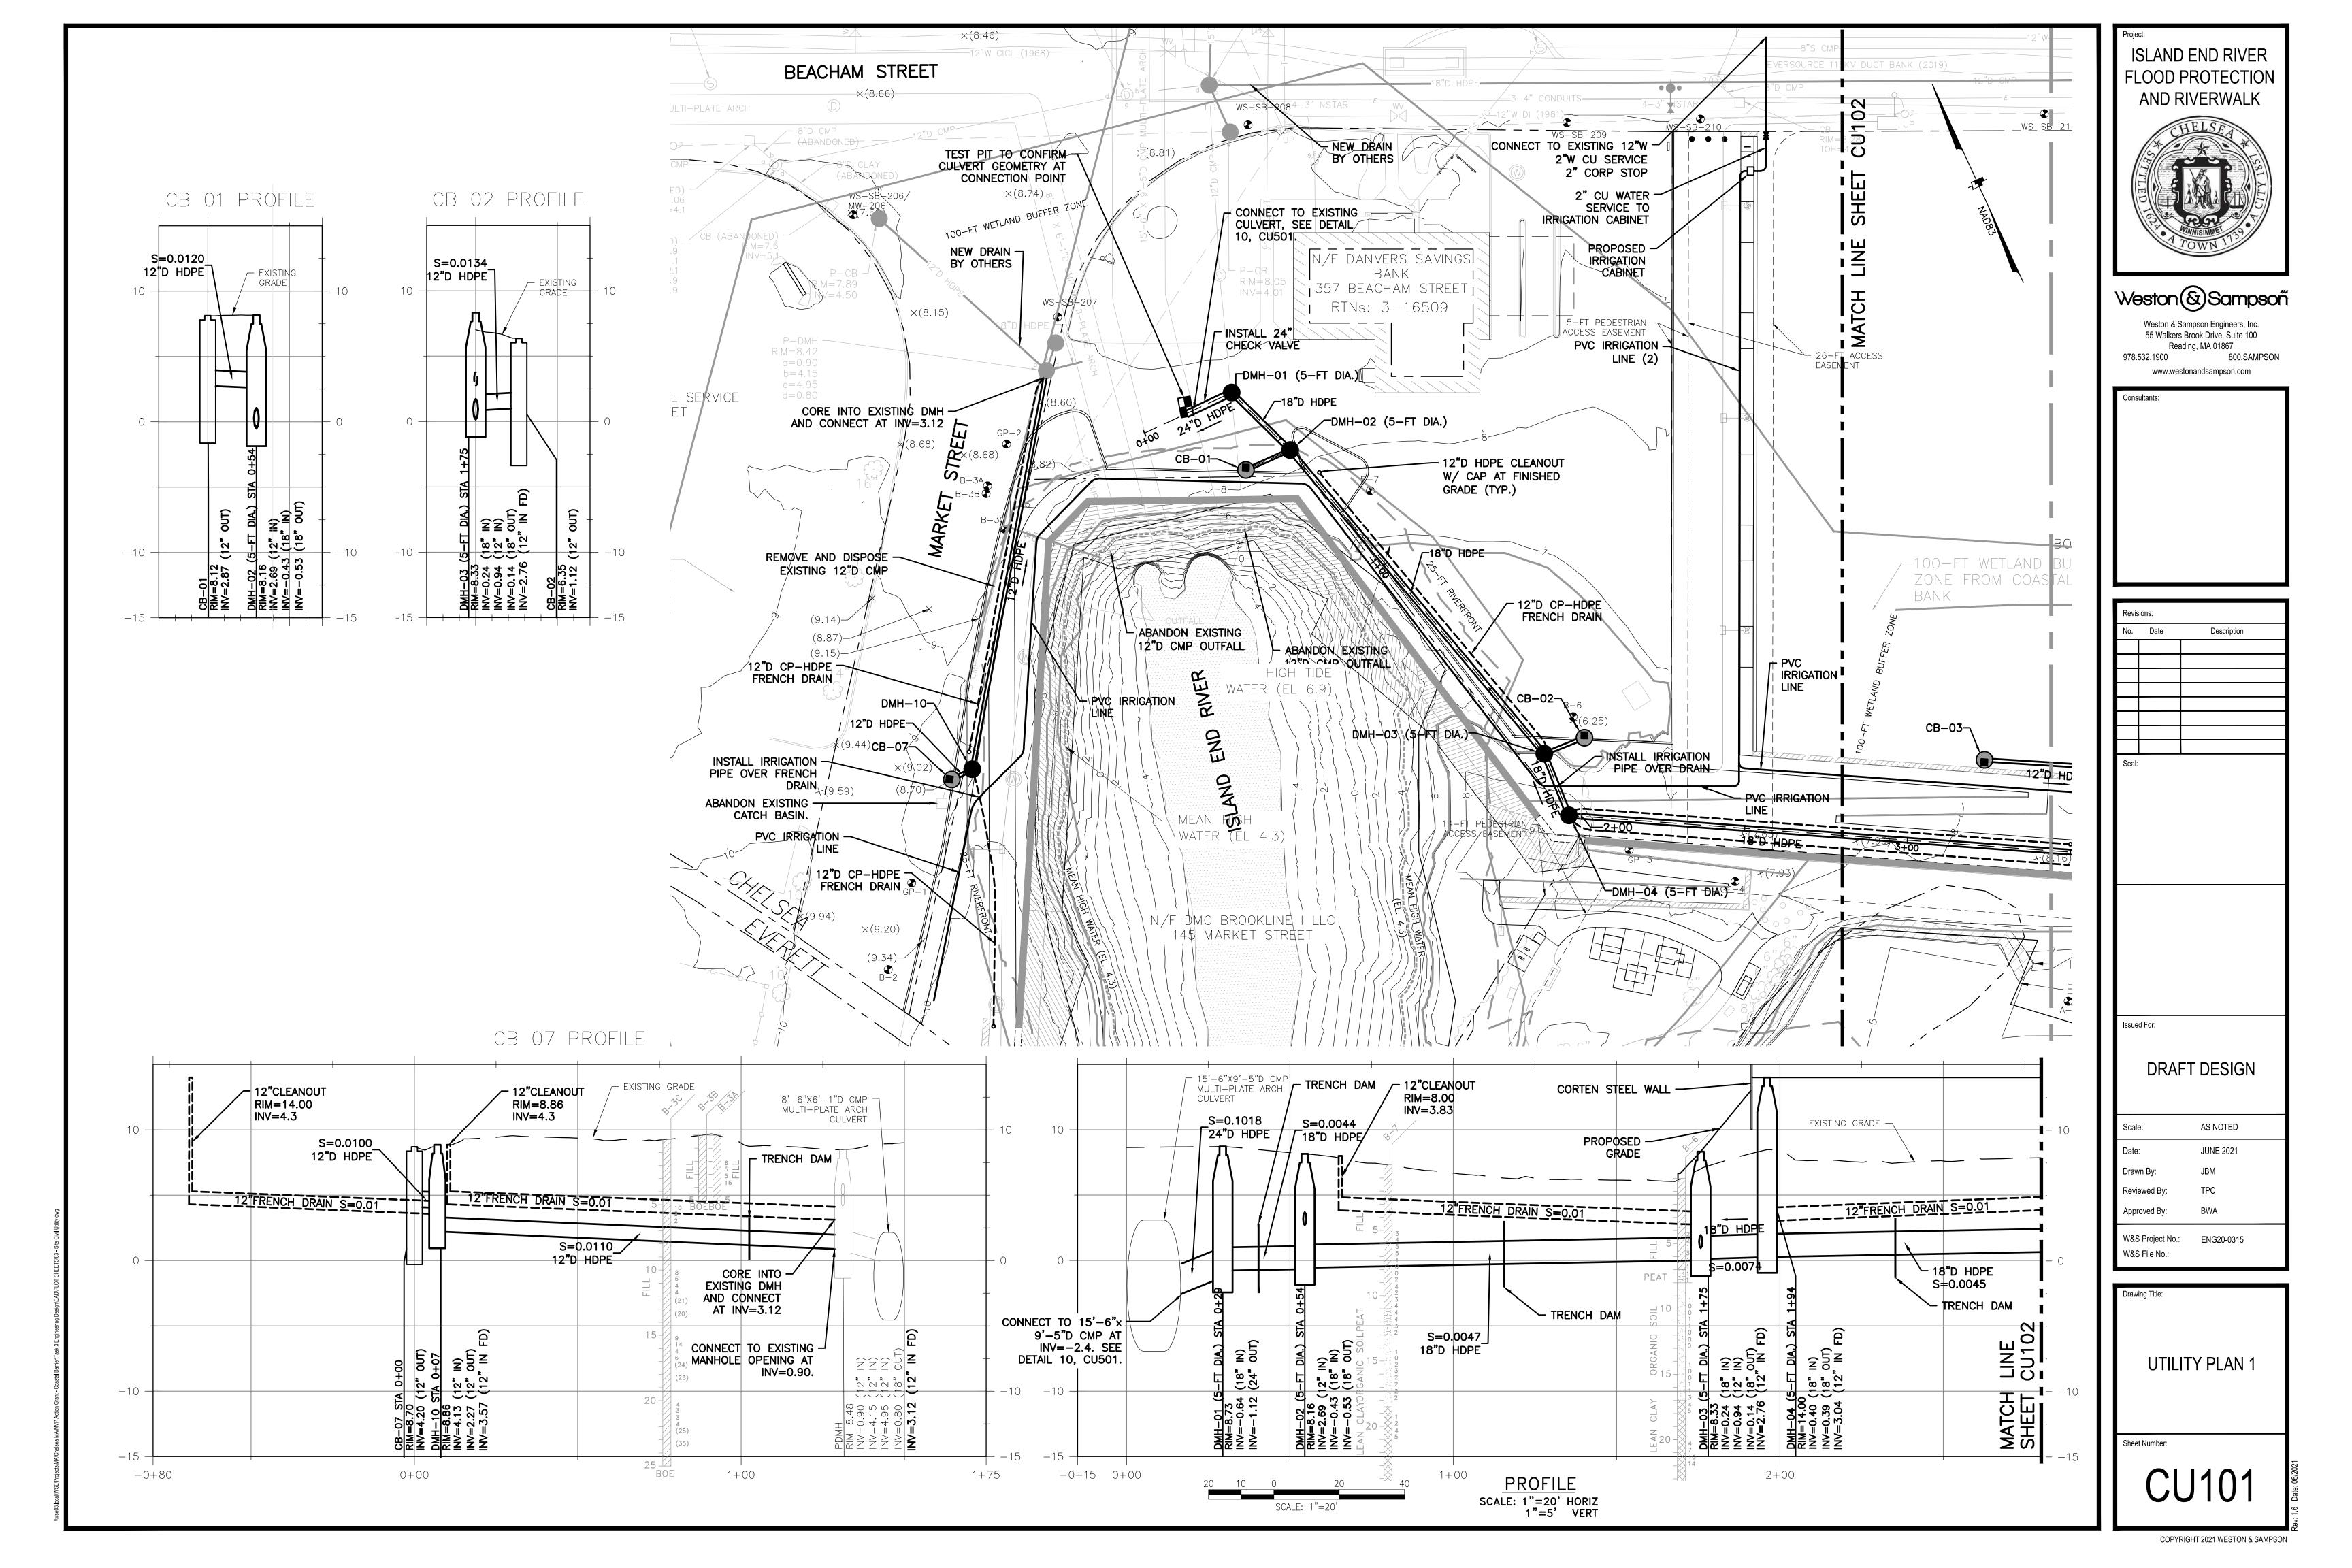
GRADE, AS SPECIFIED IN DRAWINGS.

FRENCH DRAIN DETAIL SCALE: N.T.S.

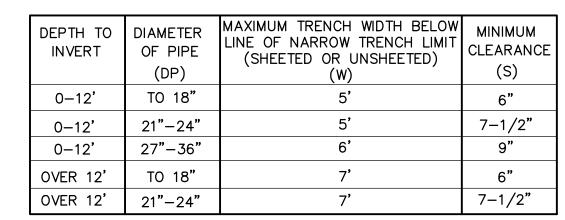


#### TABLE A




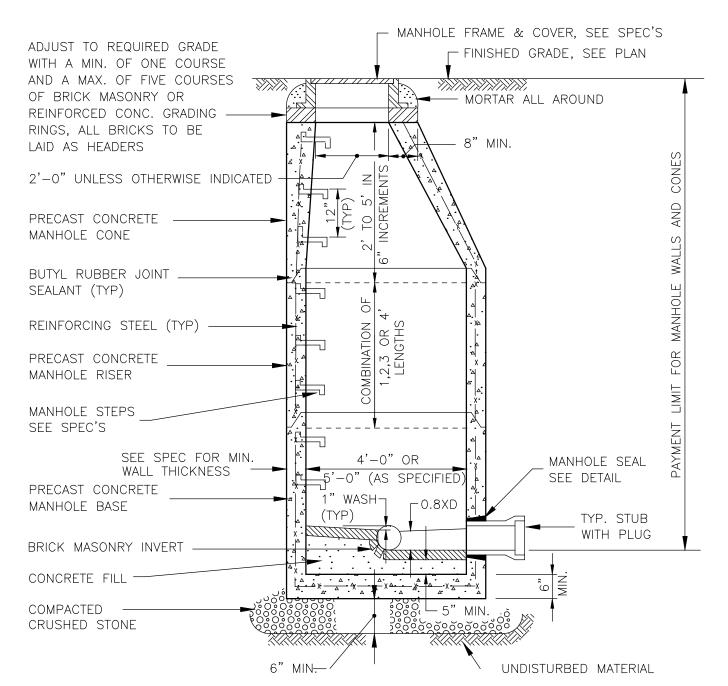





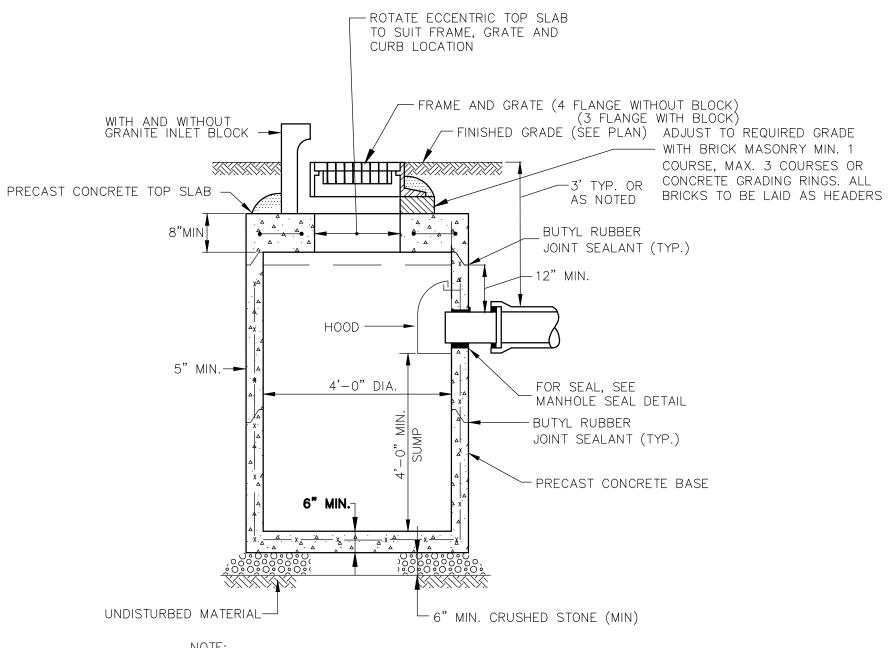


NOTE: STEEL REINFORCING TO MEET OR EXCEED H20 LOADING.

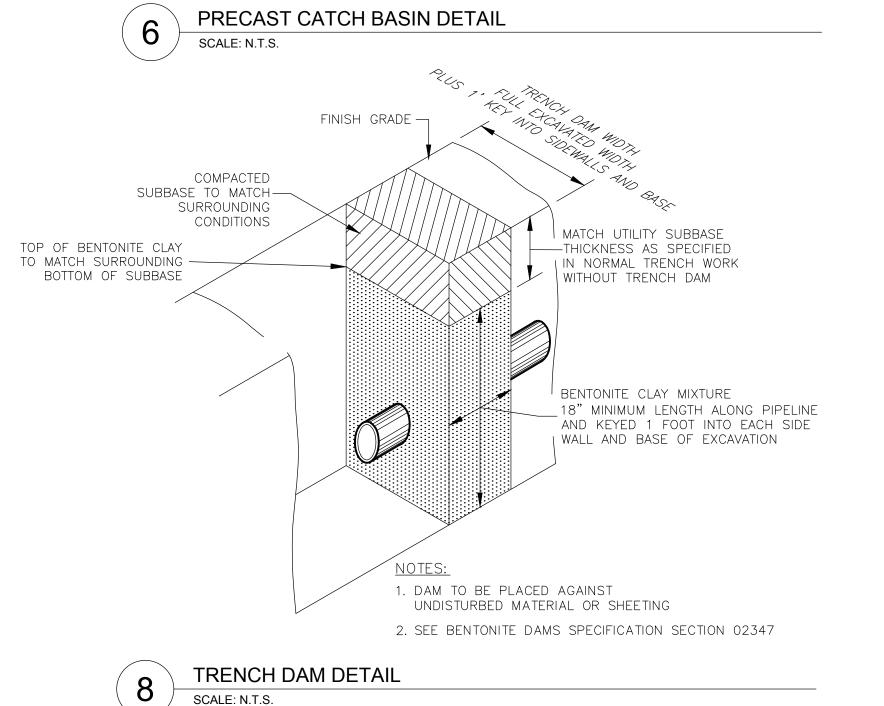


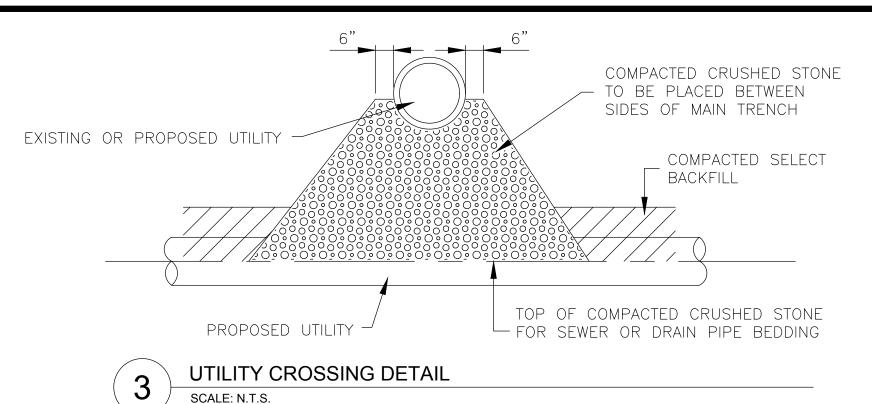

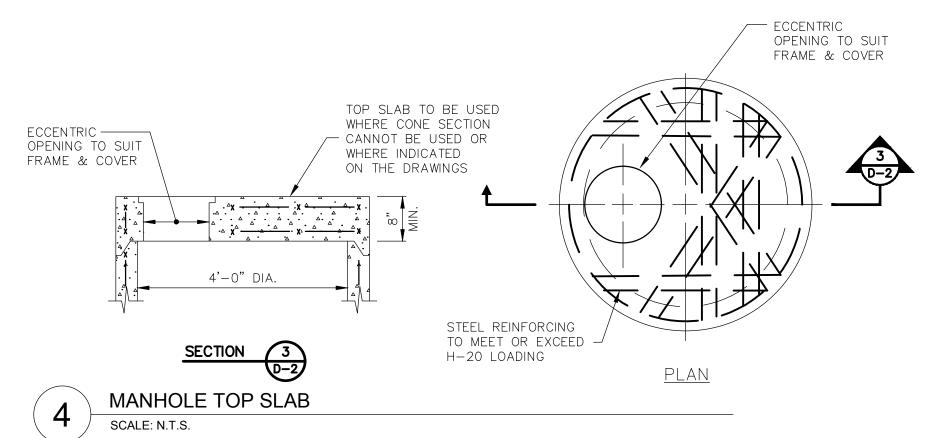


THE "DROP OVER" SECTION SHALL BE INDEPENDENTLY SUPPORTED TO ALLOW FOR PROPER CURING OF THE BASE SLAB

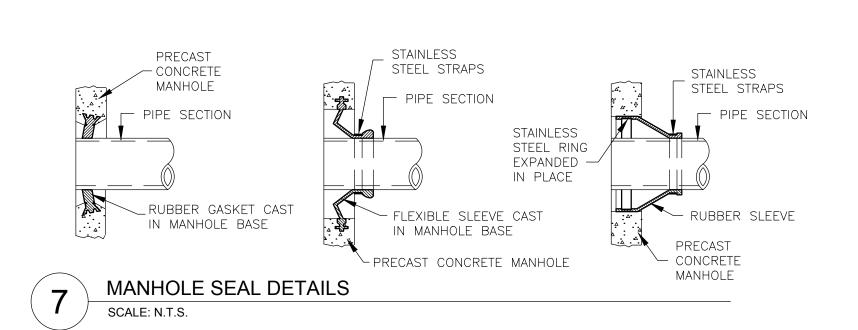

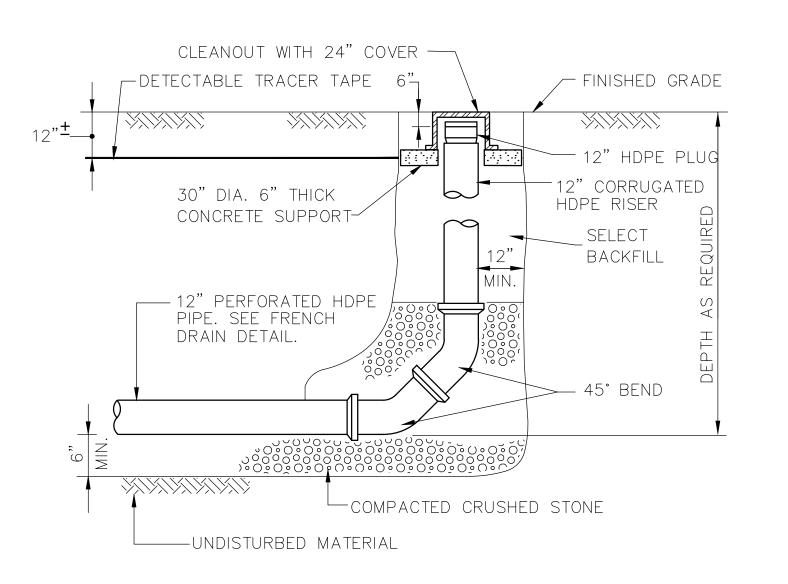


HDPE CLEANOUT DETAIL SCALE: N.T.S.

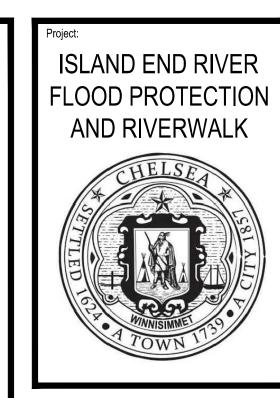

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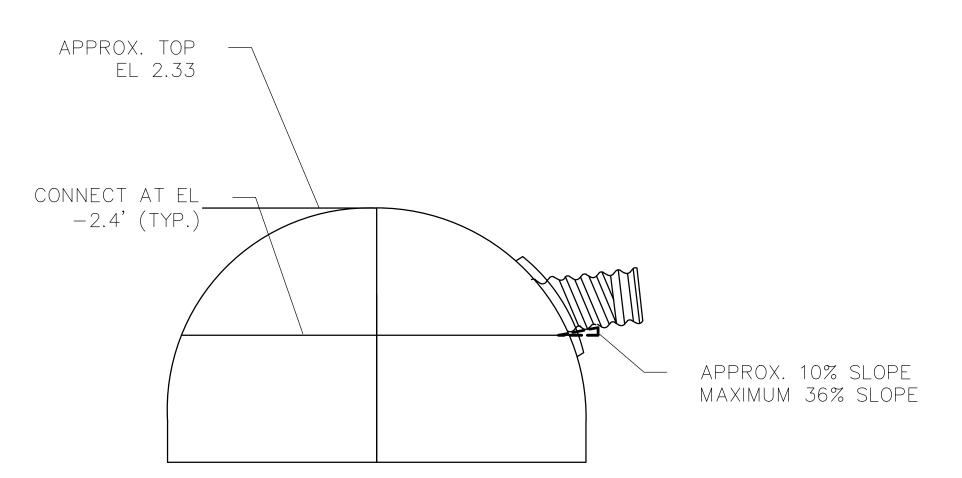
UTILITY **DETAILS 1** 

Sheet Number:

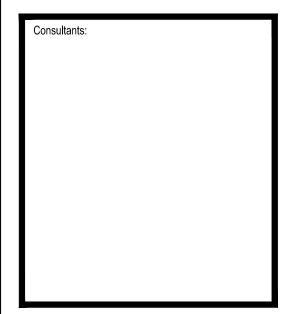
NOTE: PROVIDE SADDLE FOR ALL AC AND PVC
MAINS AND ALL 2" OR LARGER STOPS

\*1' FOR CONNECTION TO NON LEAD SERVICE
\*VARIES BASED ON DISTANCE FROM CURB STOP
TO WATER METER FOR LEAD SERVICE REPLACEMENT

10 WATER SERVICE DETAIL SCALE: N.T.S.



1 MARKET ST. CULVERT SADDLE CONNECTION DETAIL SCALE: N.T.S.

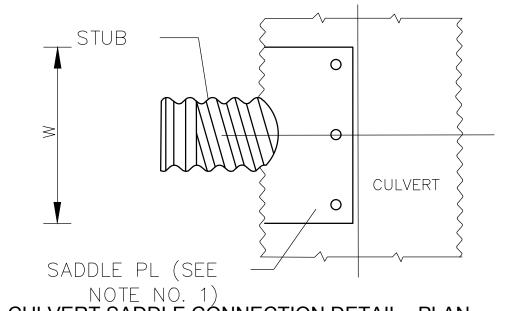

12 CULVERT SADDLE CONNECTION DETAIL - PLAN scale: N.T.S.

PRO-STIK BUTYL RUBBER ("TC40") OR EQUAL AND CULVERT PIPE MANUS-BOND POLYSUL-GRIP TAPE OR EQUAL

CULVERT SADDLE CONNECTION DETAIL
SCALE: N.T.S.

CULVERT DETAIL NOTES:

1. SADDLE PLATES ARE THE SAME GAGE OR ONE GAGE HEAVIER THAN

THE MAINLINE, SEE SPECIFICATION 05500


2. CONFIRM GEOMETRY AND SECTION PROFILE VIA TEST PIT AT POINT OF CONNECTION PRIOR TO MANUFACTURE. SUPPLY ANGLE  $\Delta$  FOR OTHER THAN 90°.

3. W = (DIA.+12")/SIN∆ 4. STRUCTURAL FASTENERS ARE 1/4" SELF TAPPING SCREWS WITH #5 POINT

CORRUGATED TYPF	MINIMUM NUMBER & S SCREWS F	PACING OF BOLTS OR REQUIRED
	LONGITUDINAL	CIRCUMFERENTIAL
2-2/3" X 1/2"	EVERY 2ND CREST	6"
3" X 1"	EVERY 2ND CREST	6"
5" X 1"	EVERY 2ND CREST	6"


TABLE 1: CULVERT CONNECTION REQUIREMENTS

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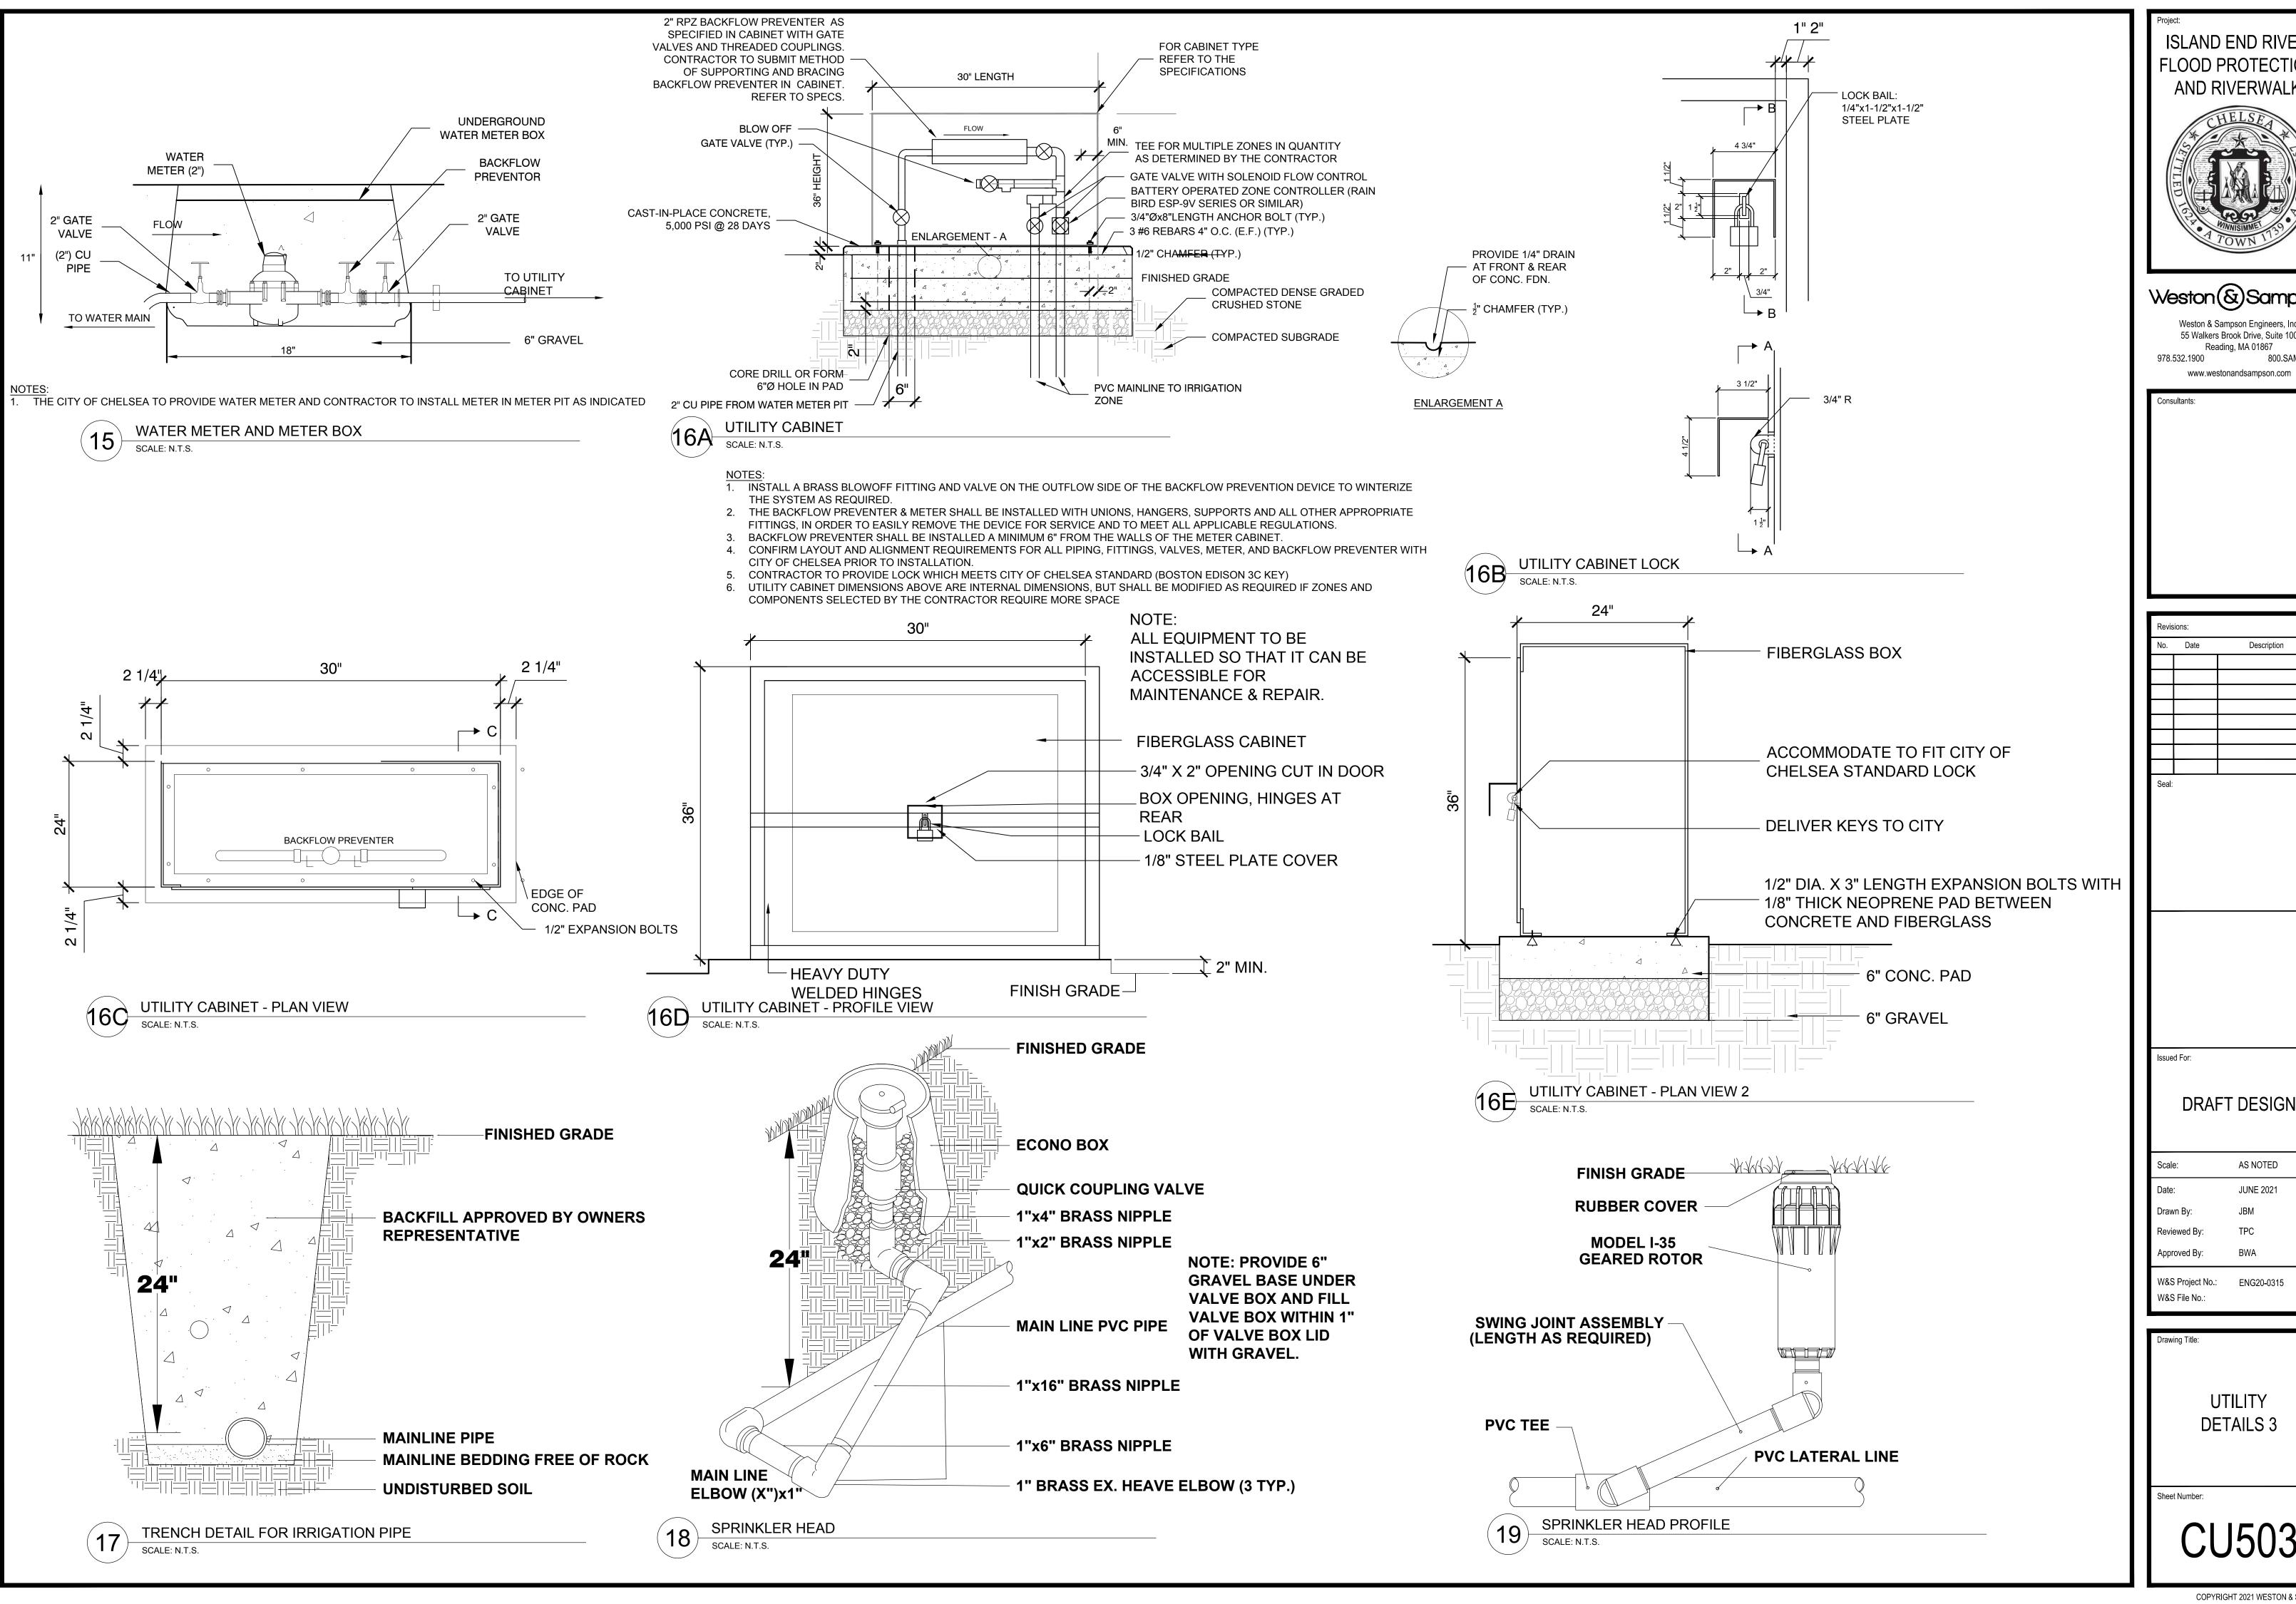
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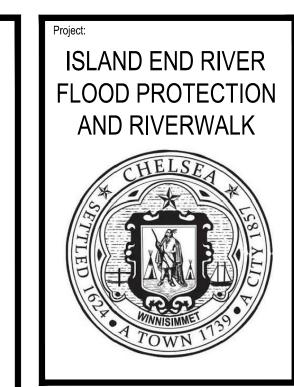
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UTILITY DETAILS 2

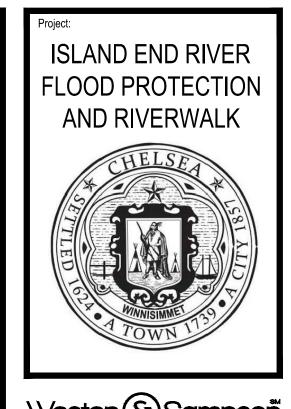
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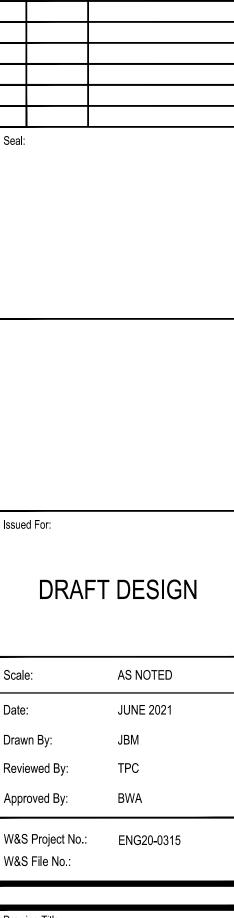





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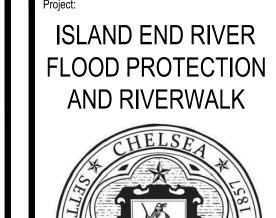

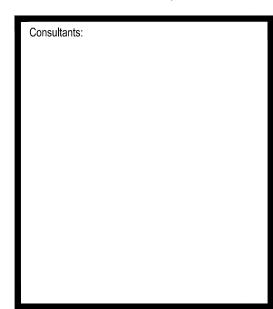
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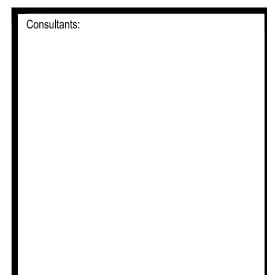
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GRADING PLAN 1	

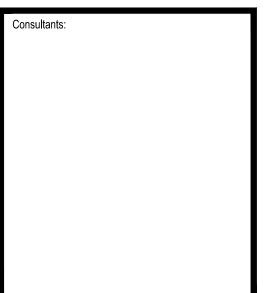

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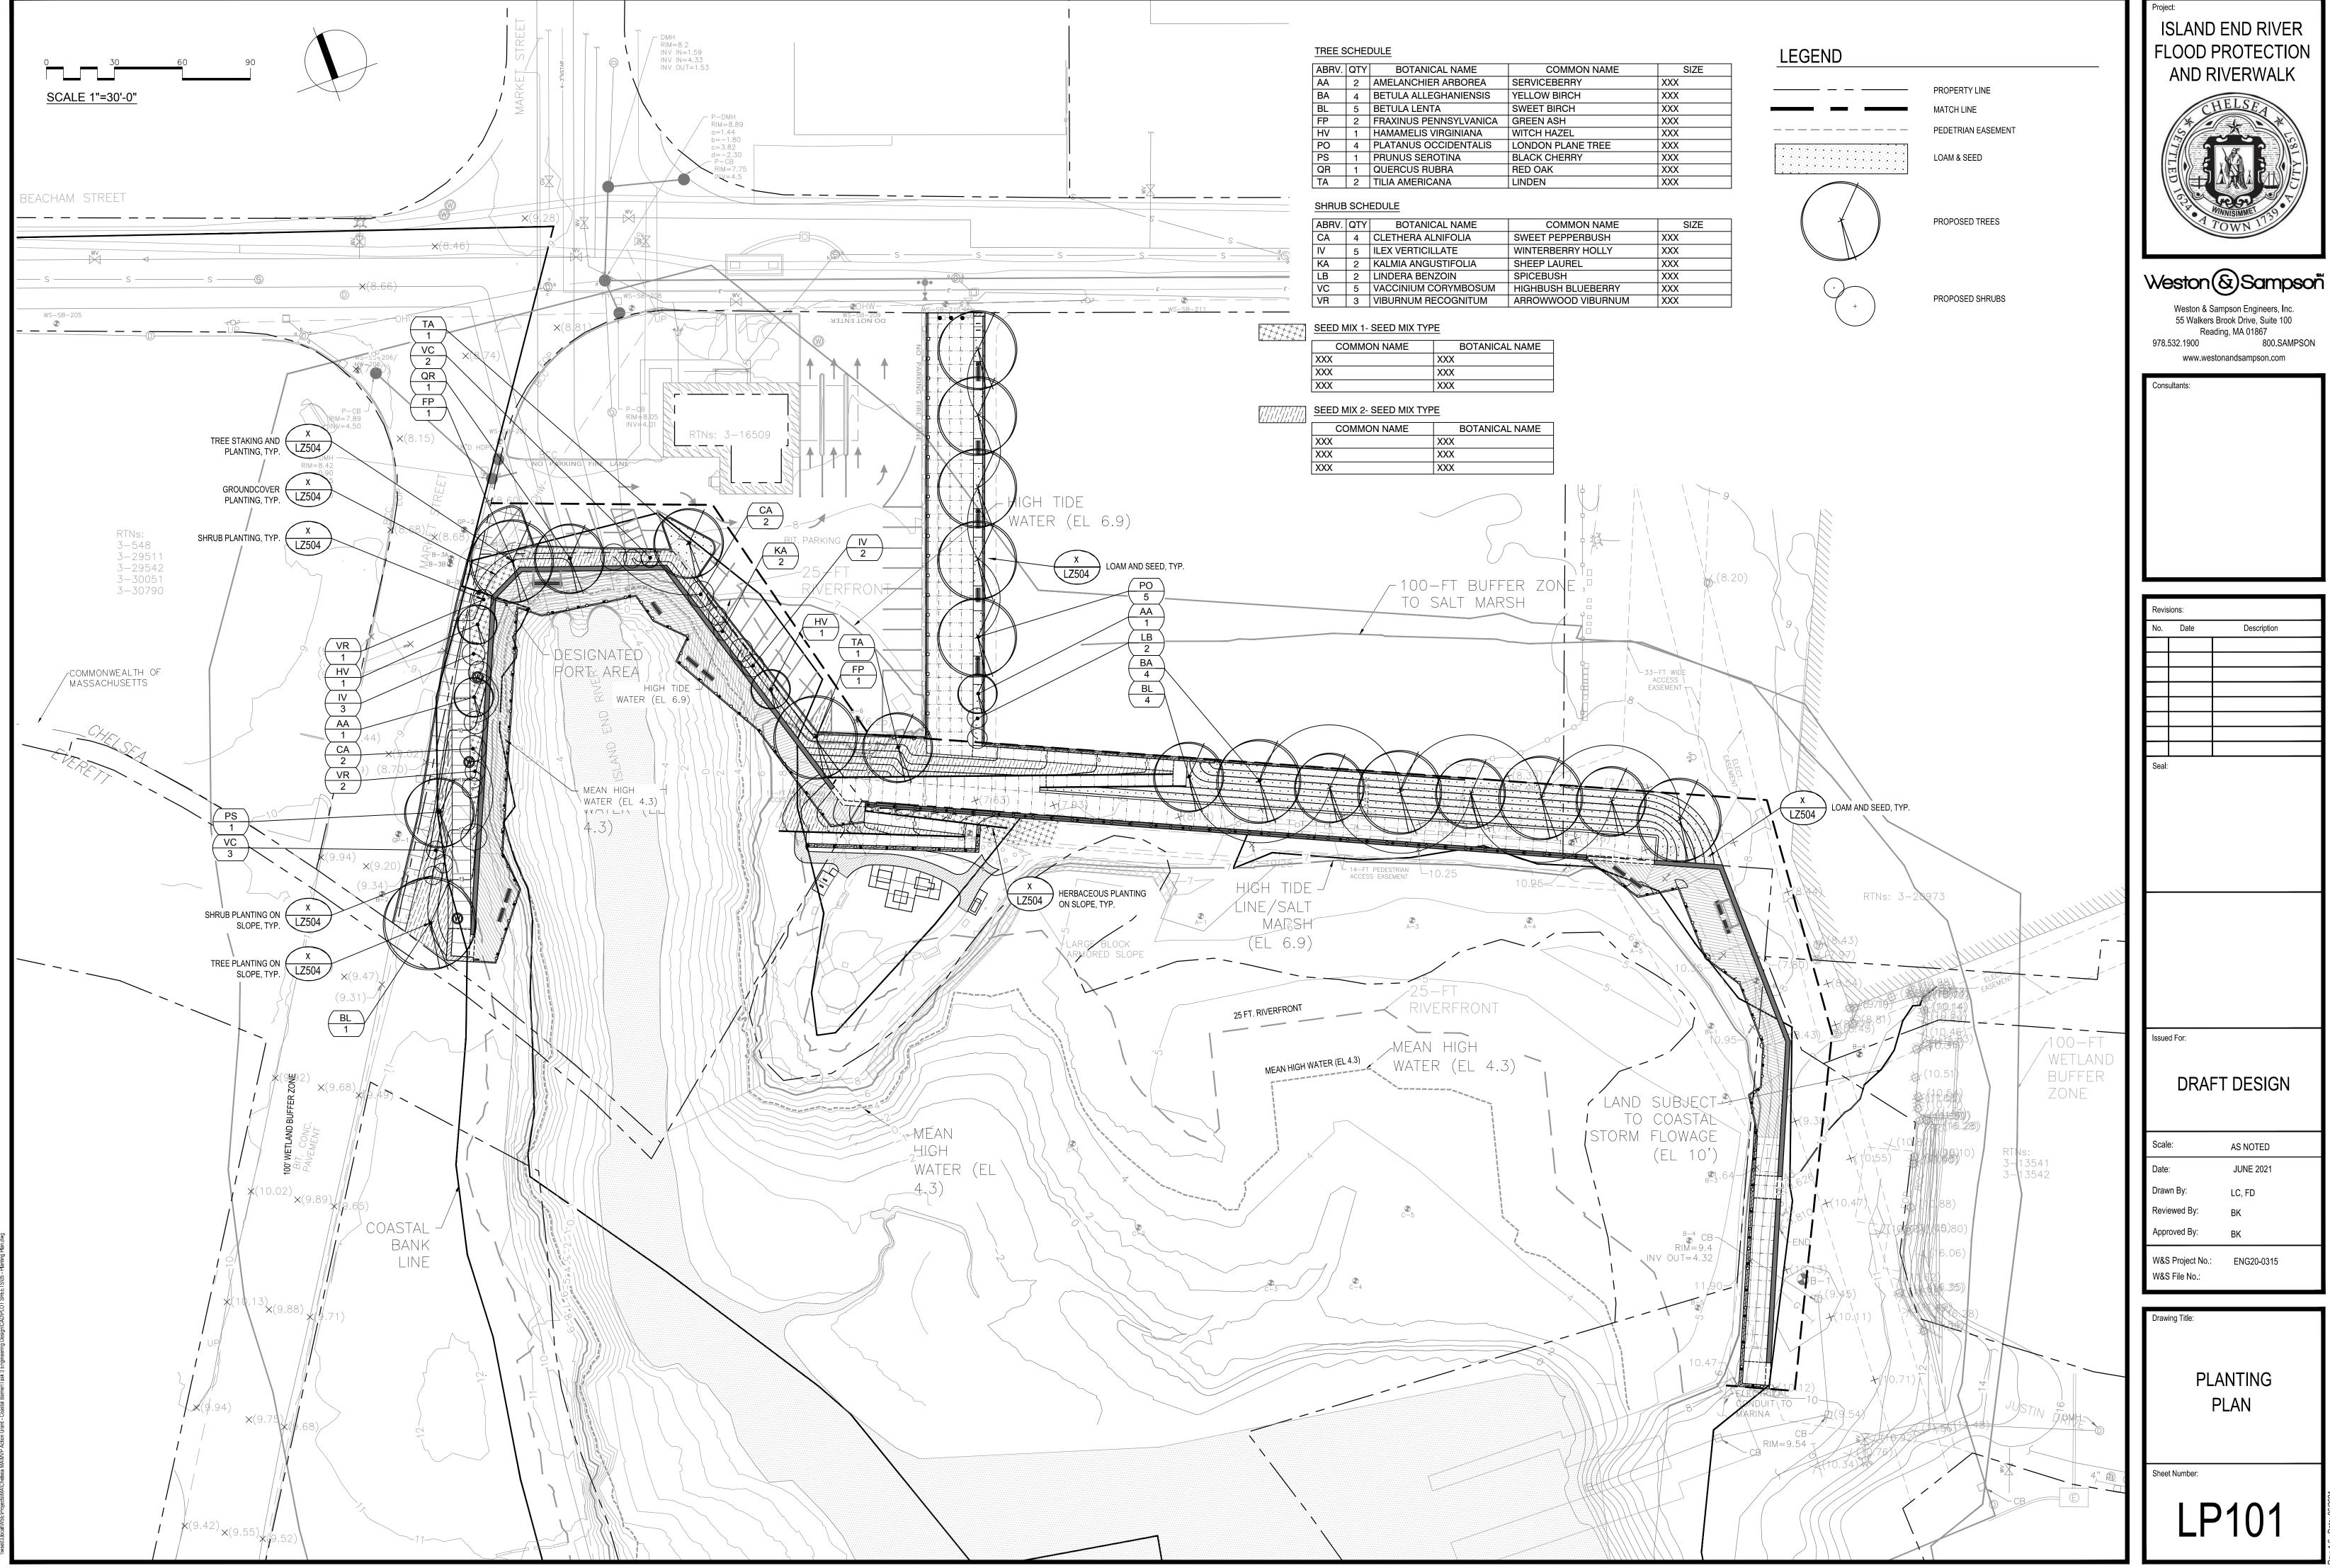
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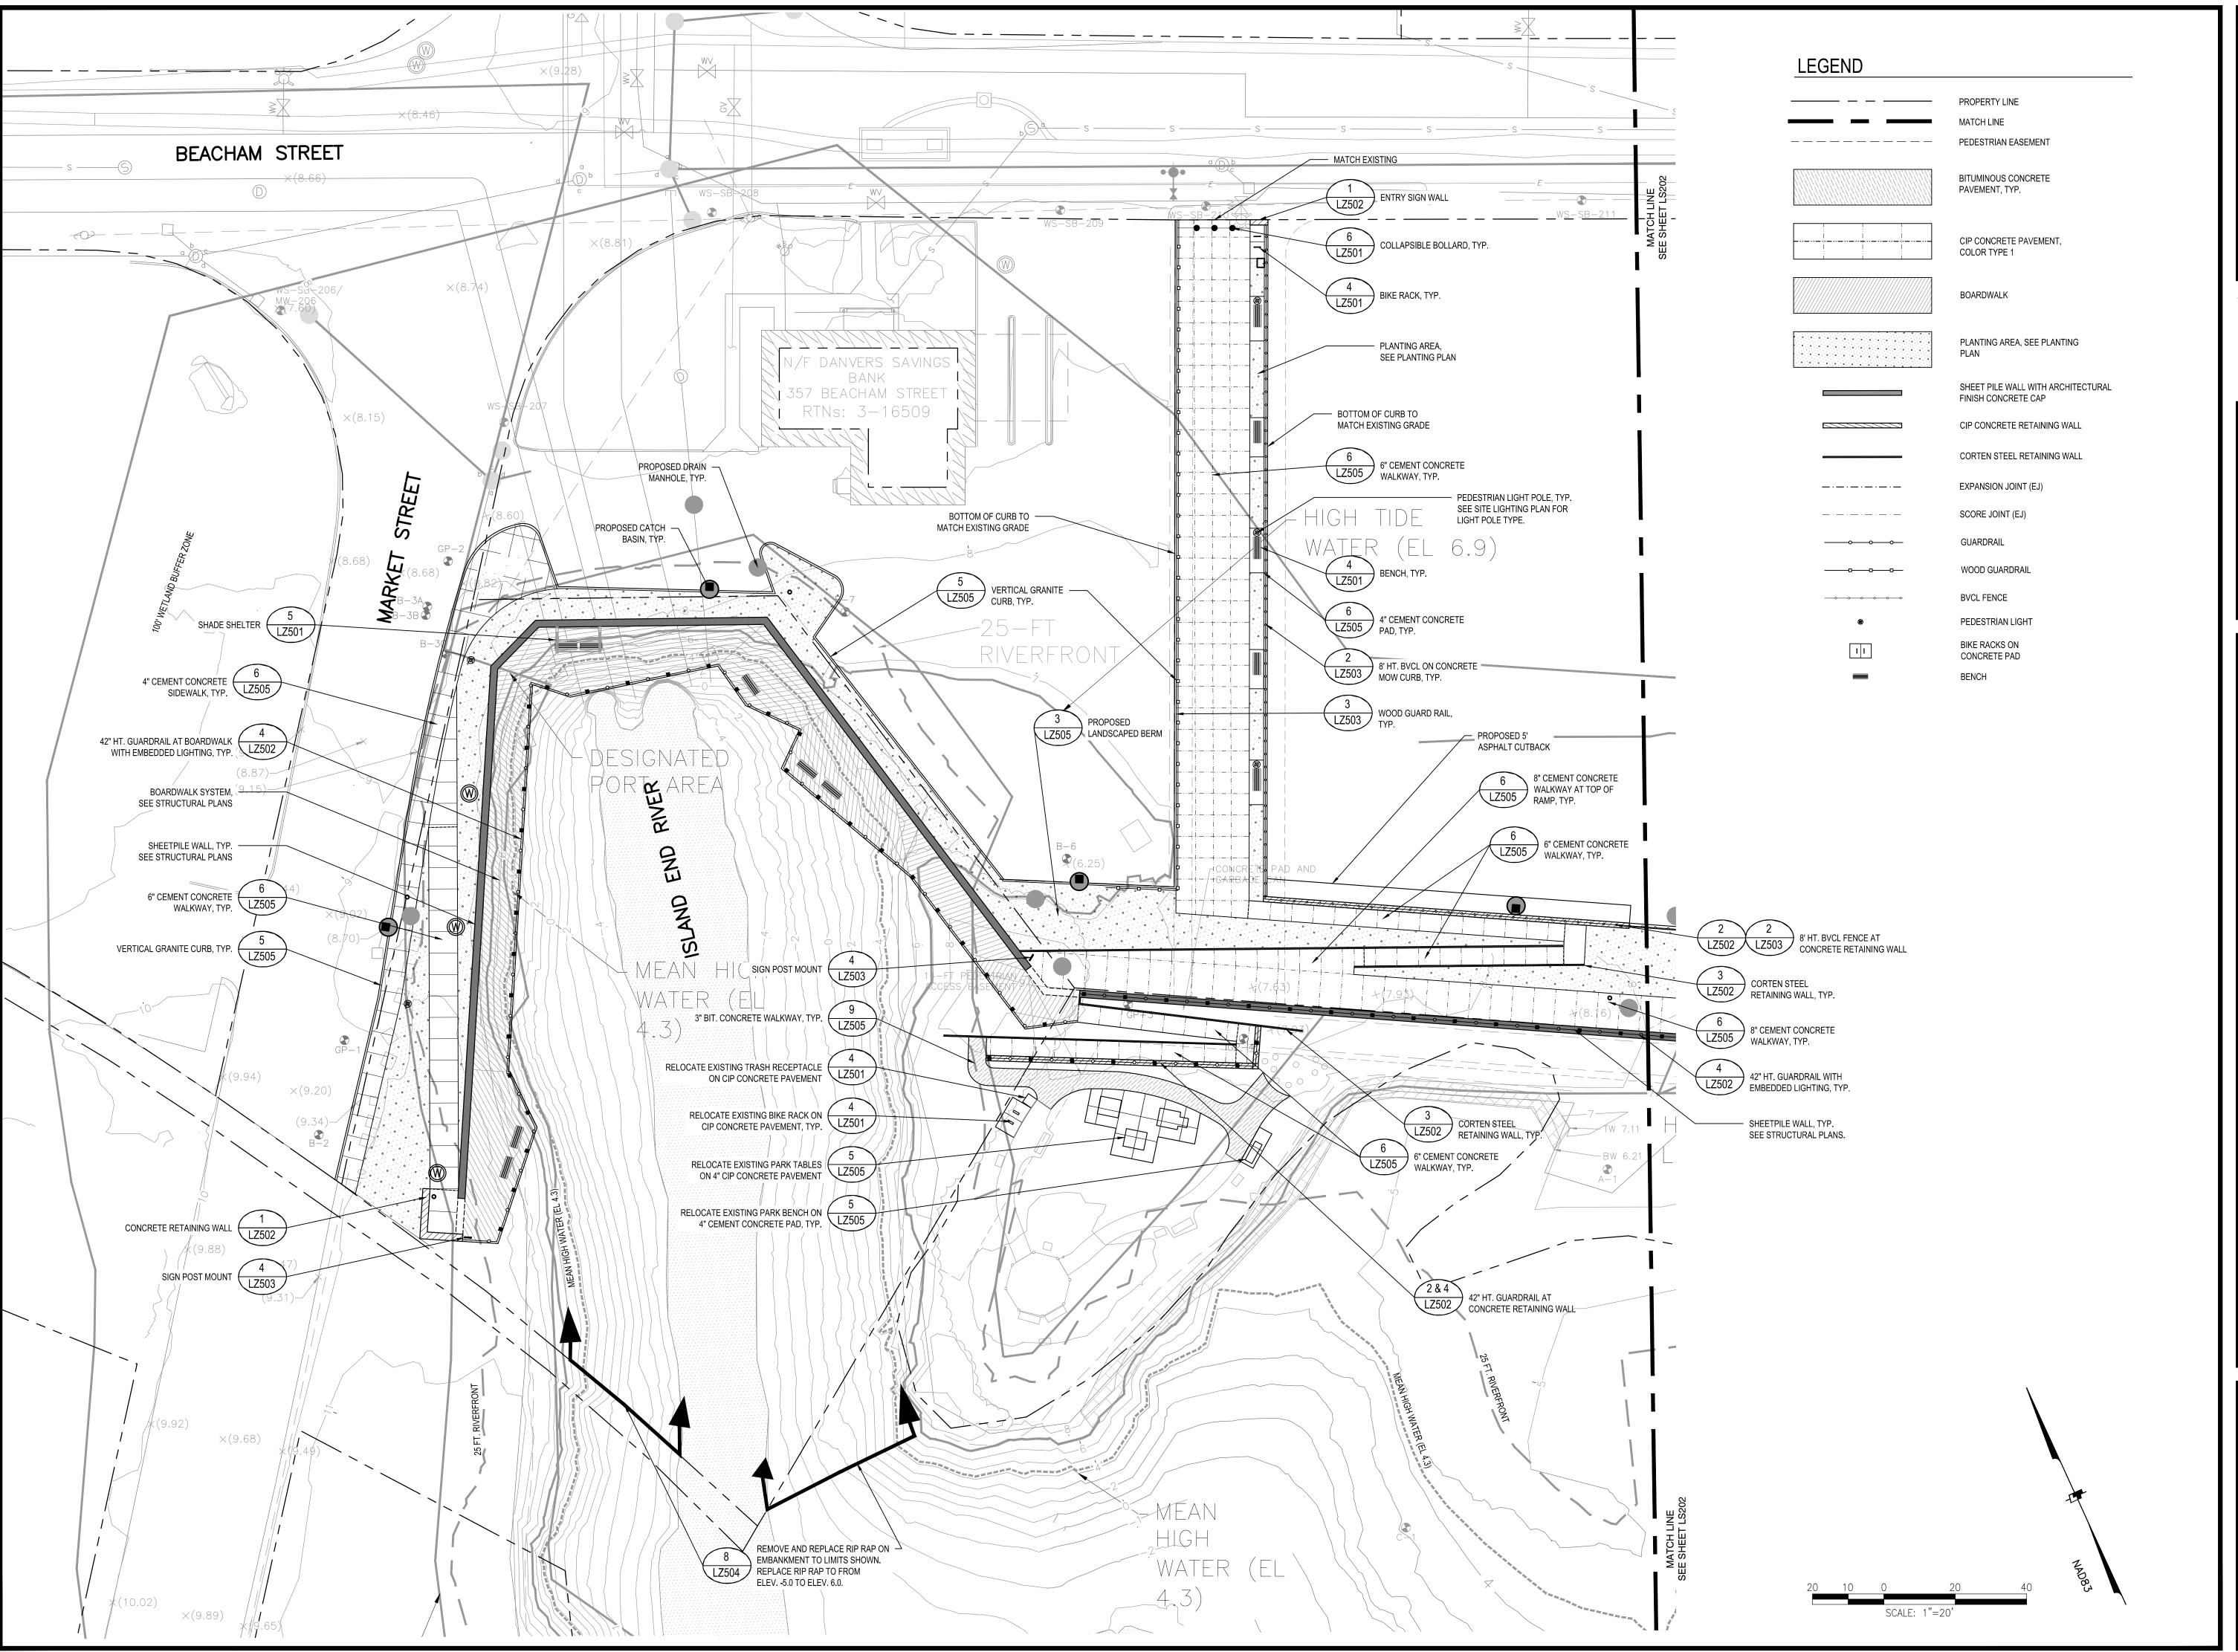
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**GRADING PLAN 2** 

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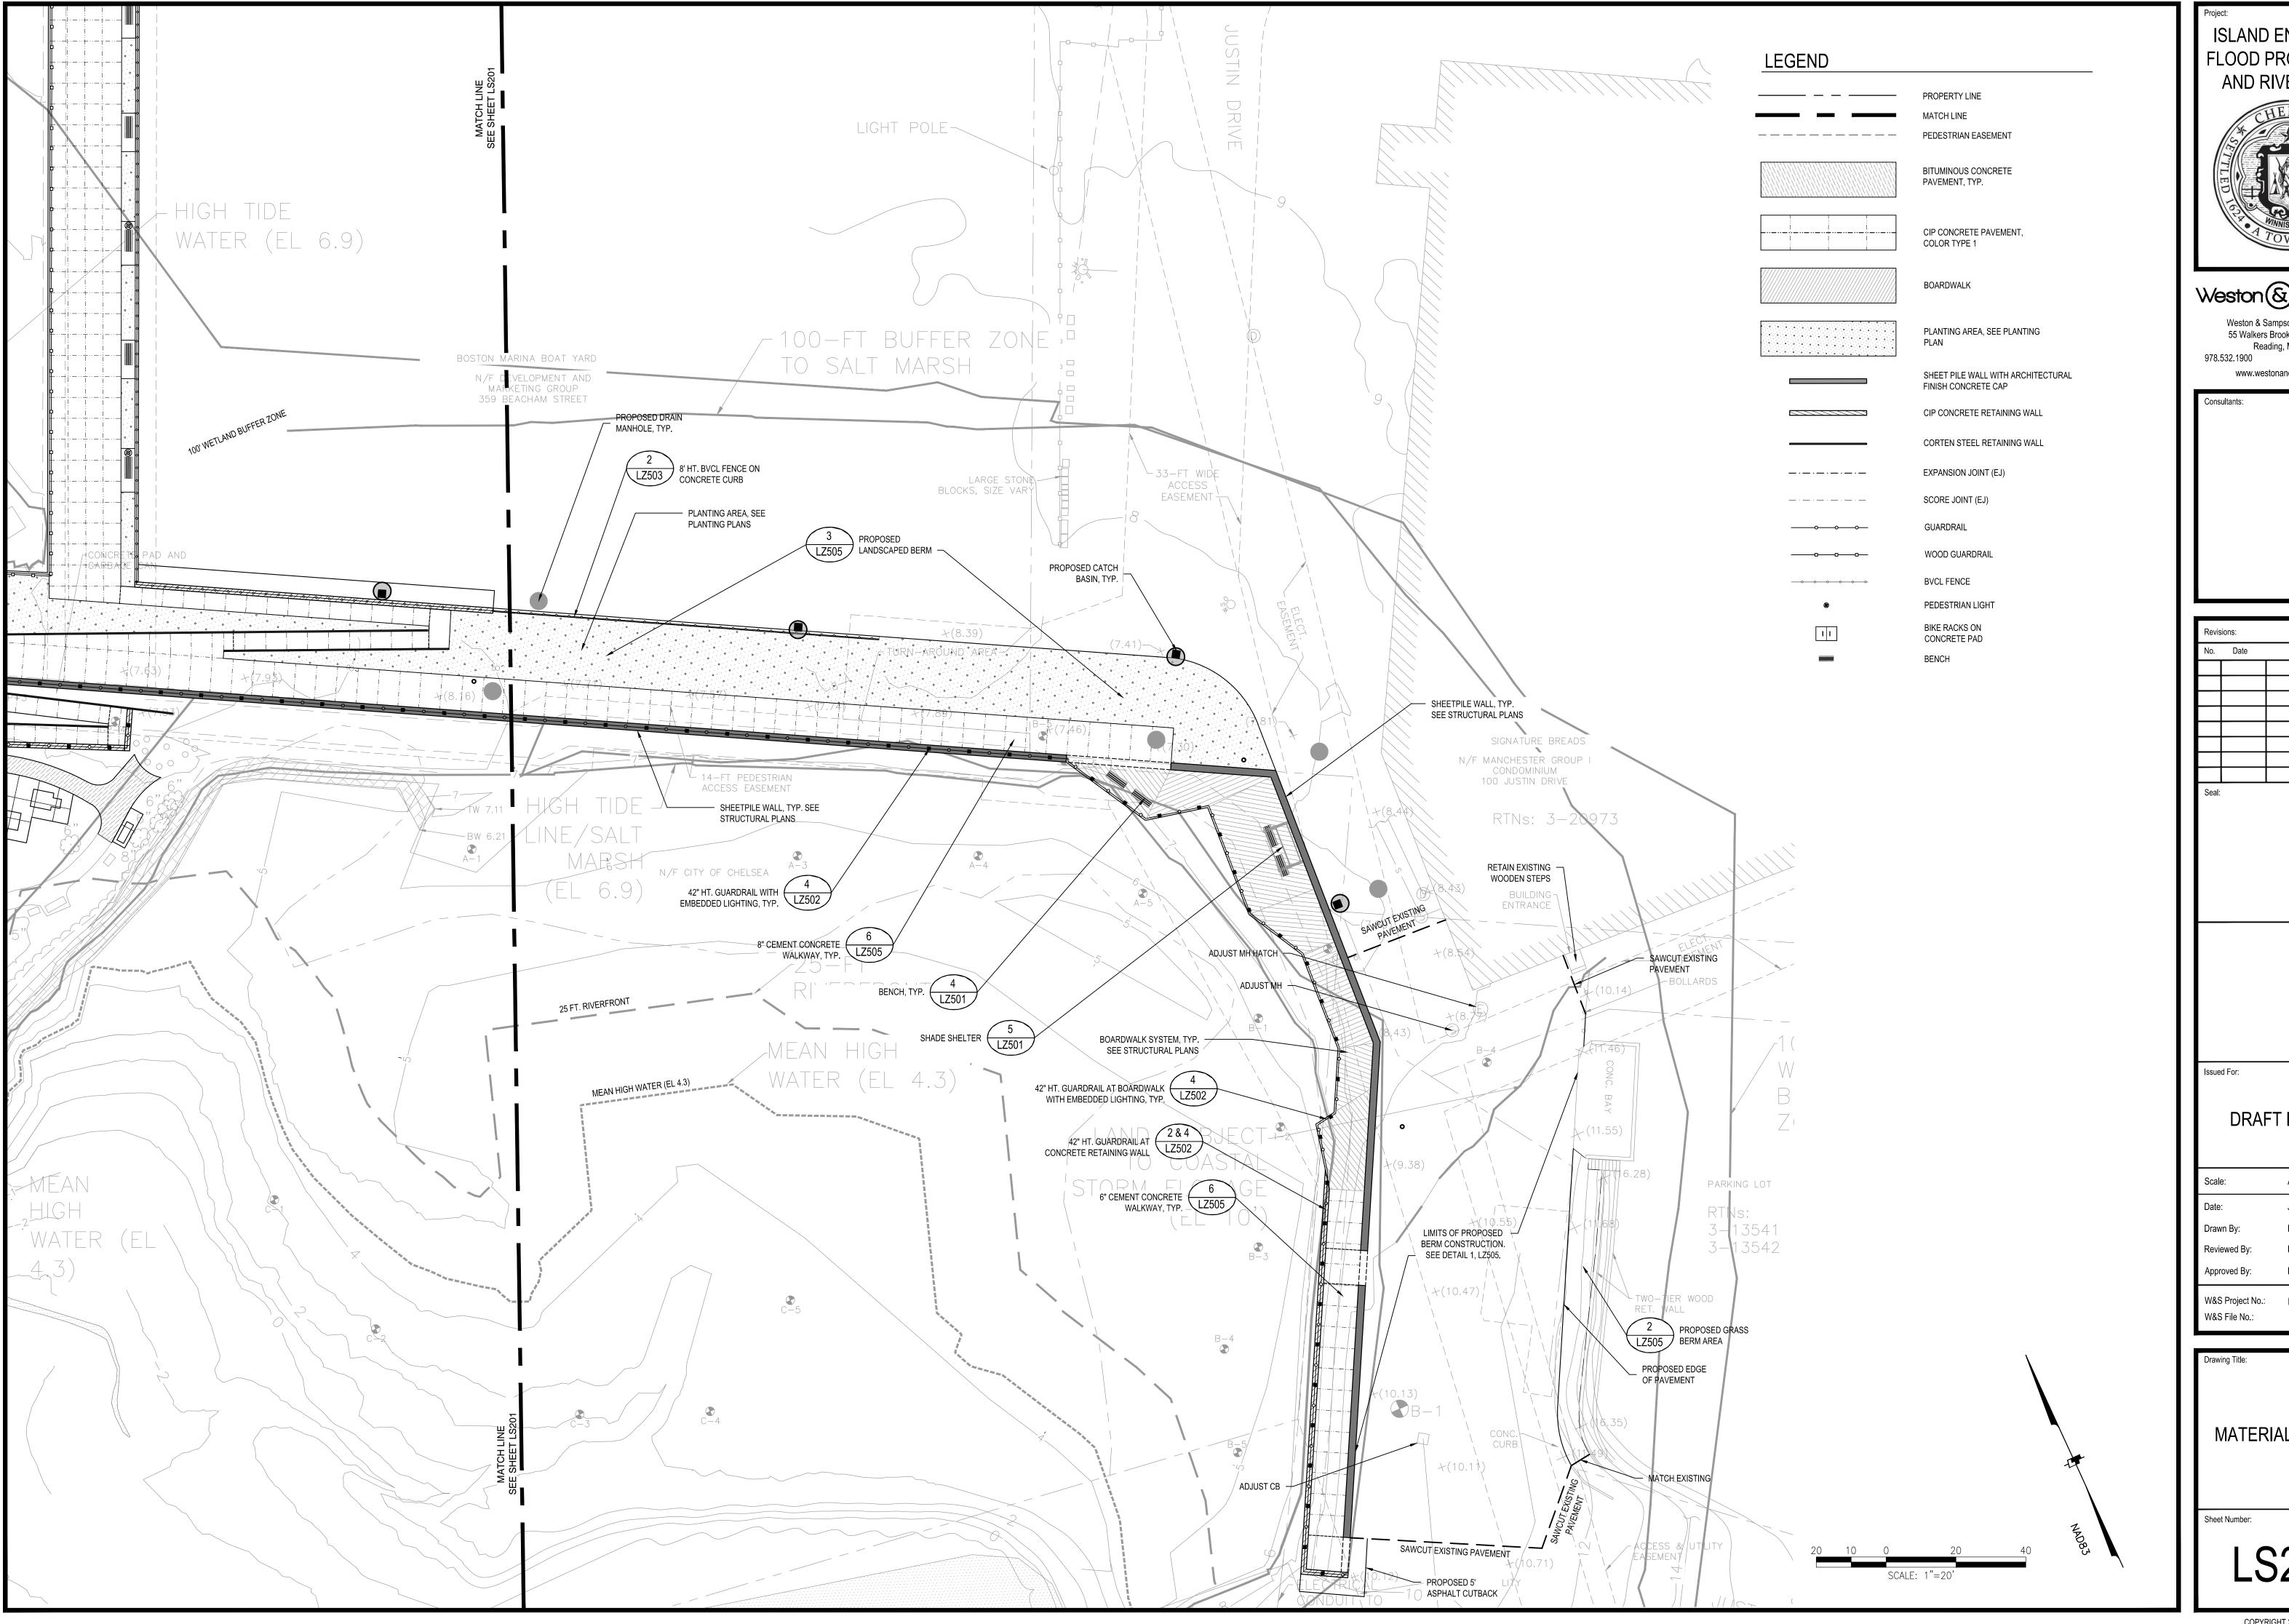
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MATERIALS PLAN 1
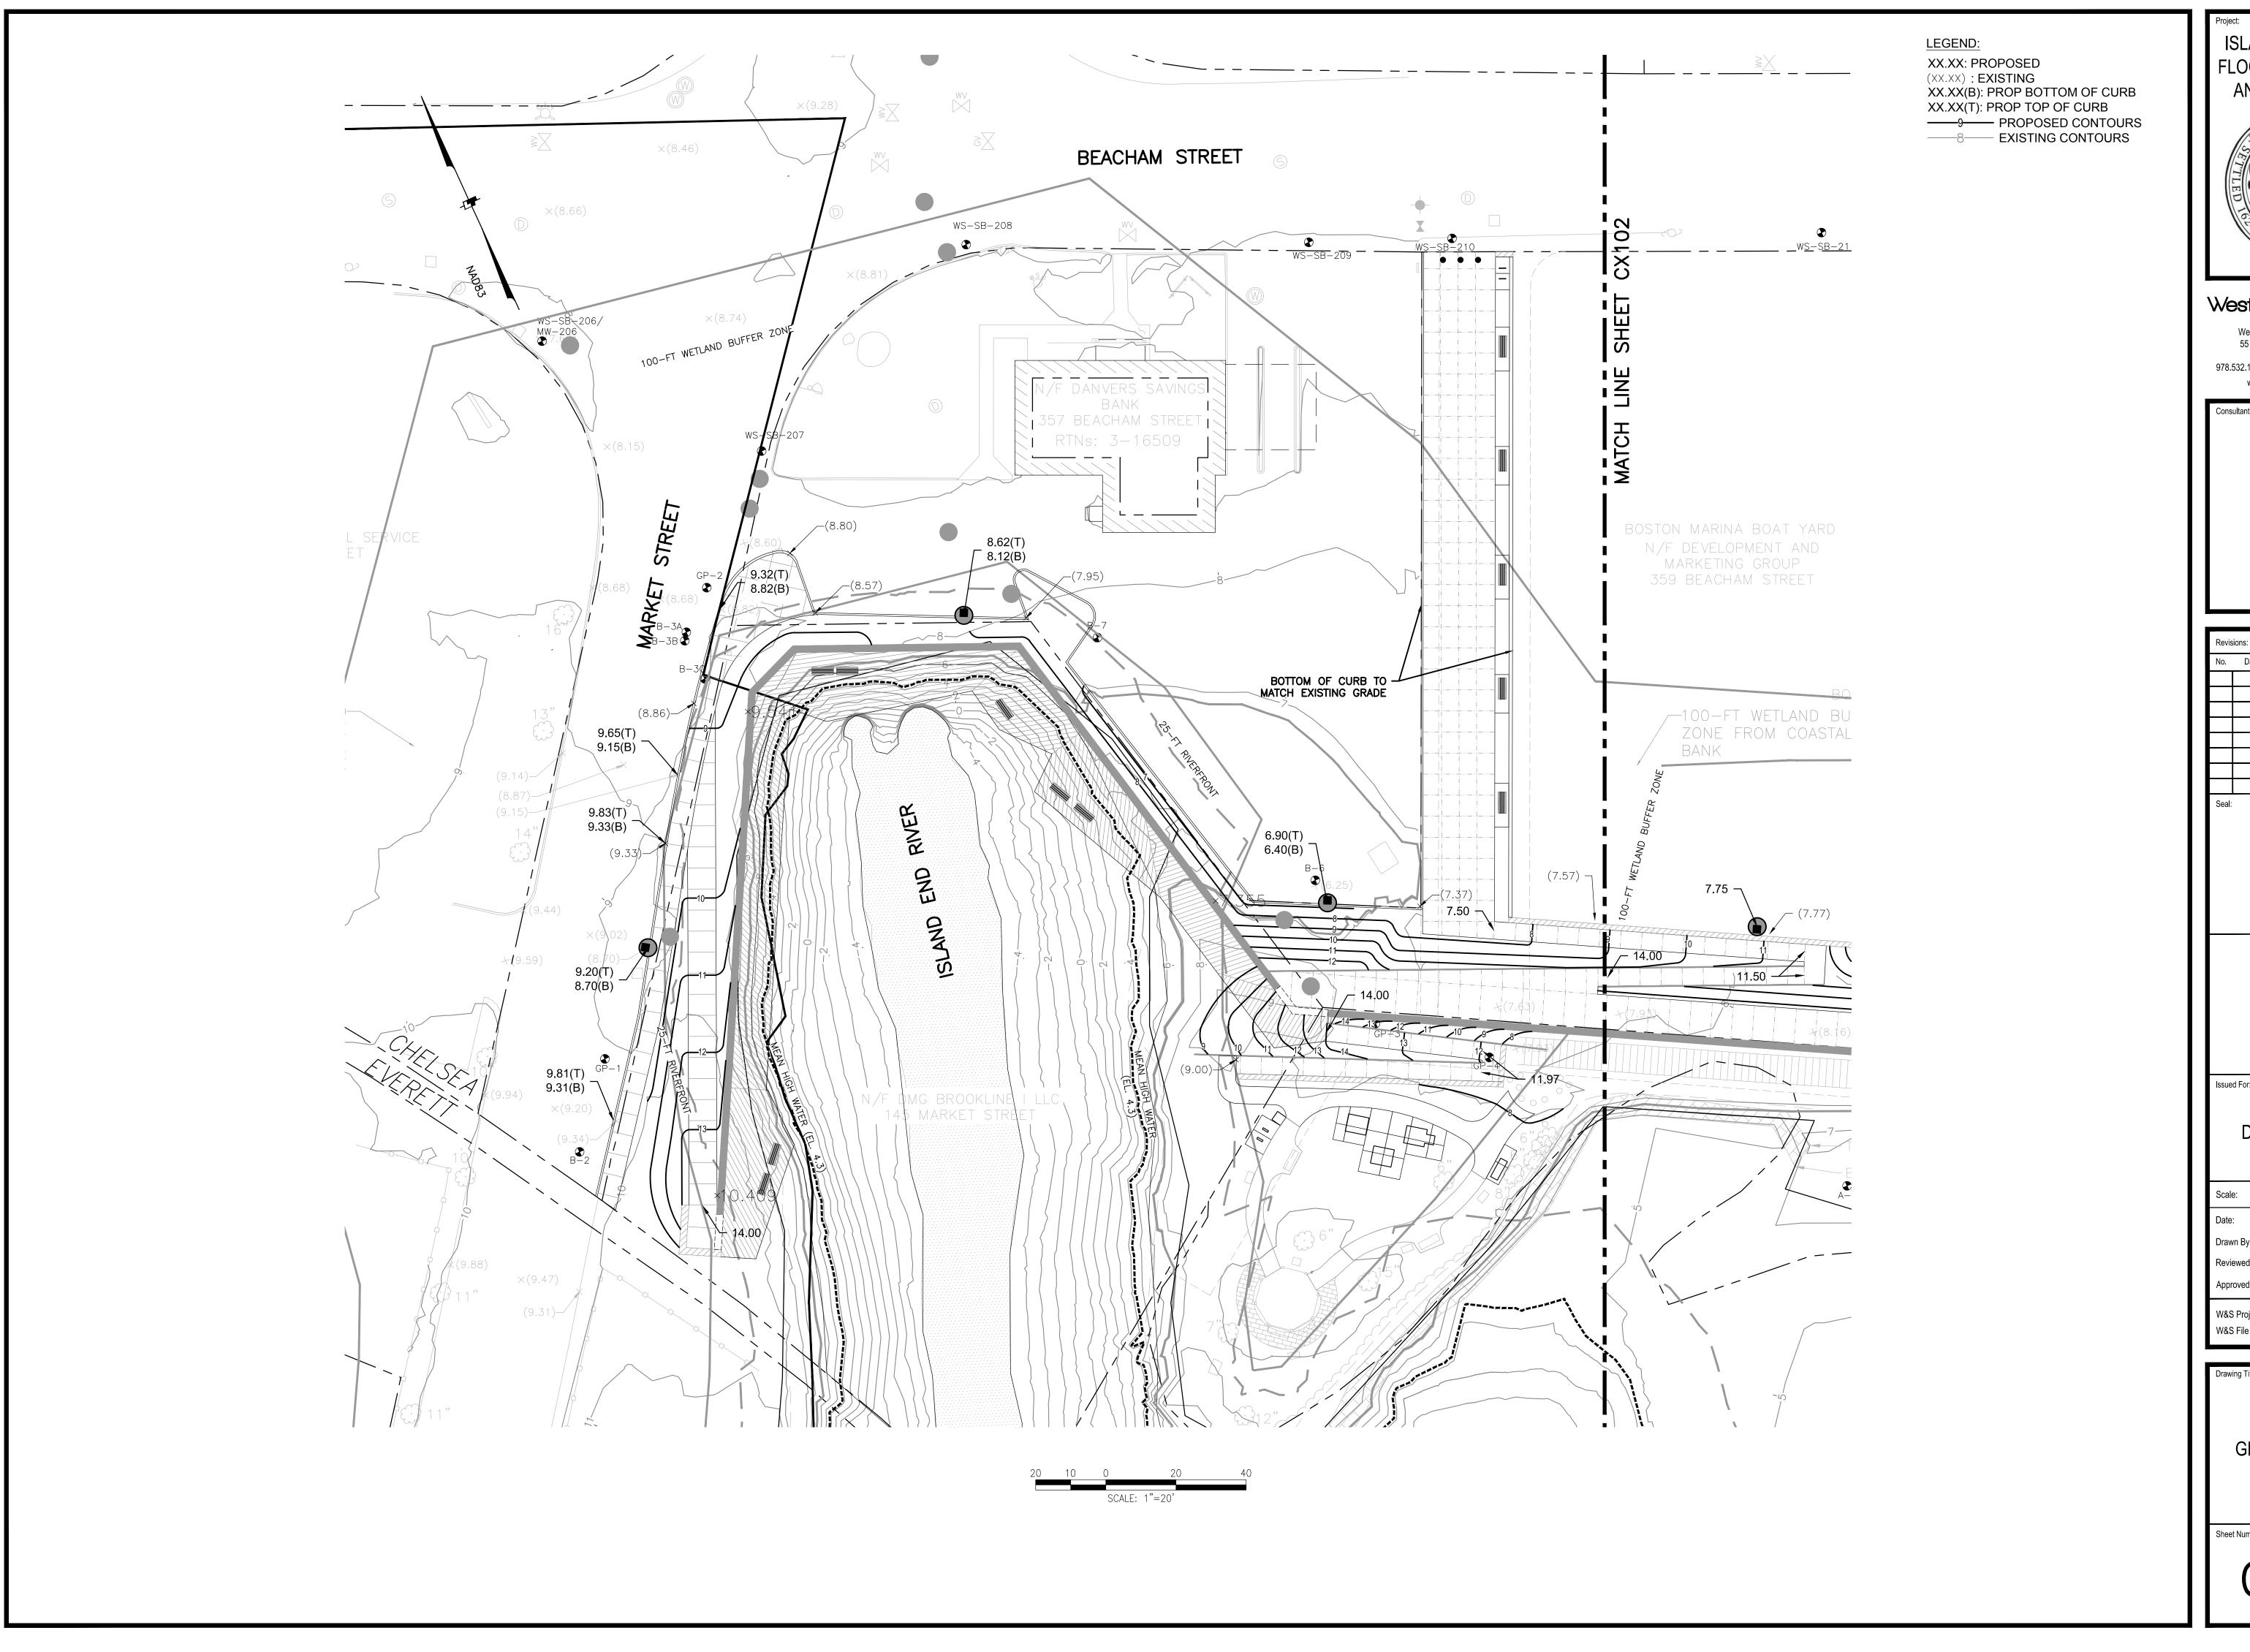
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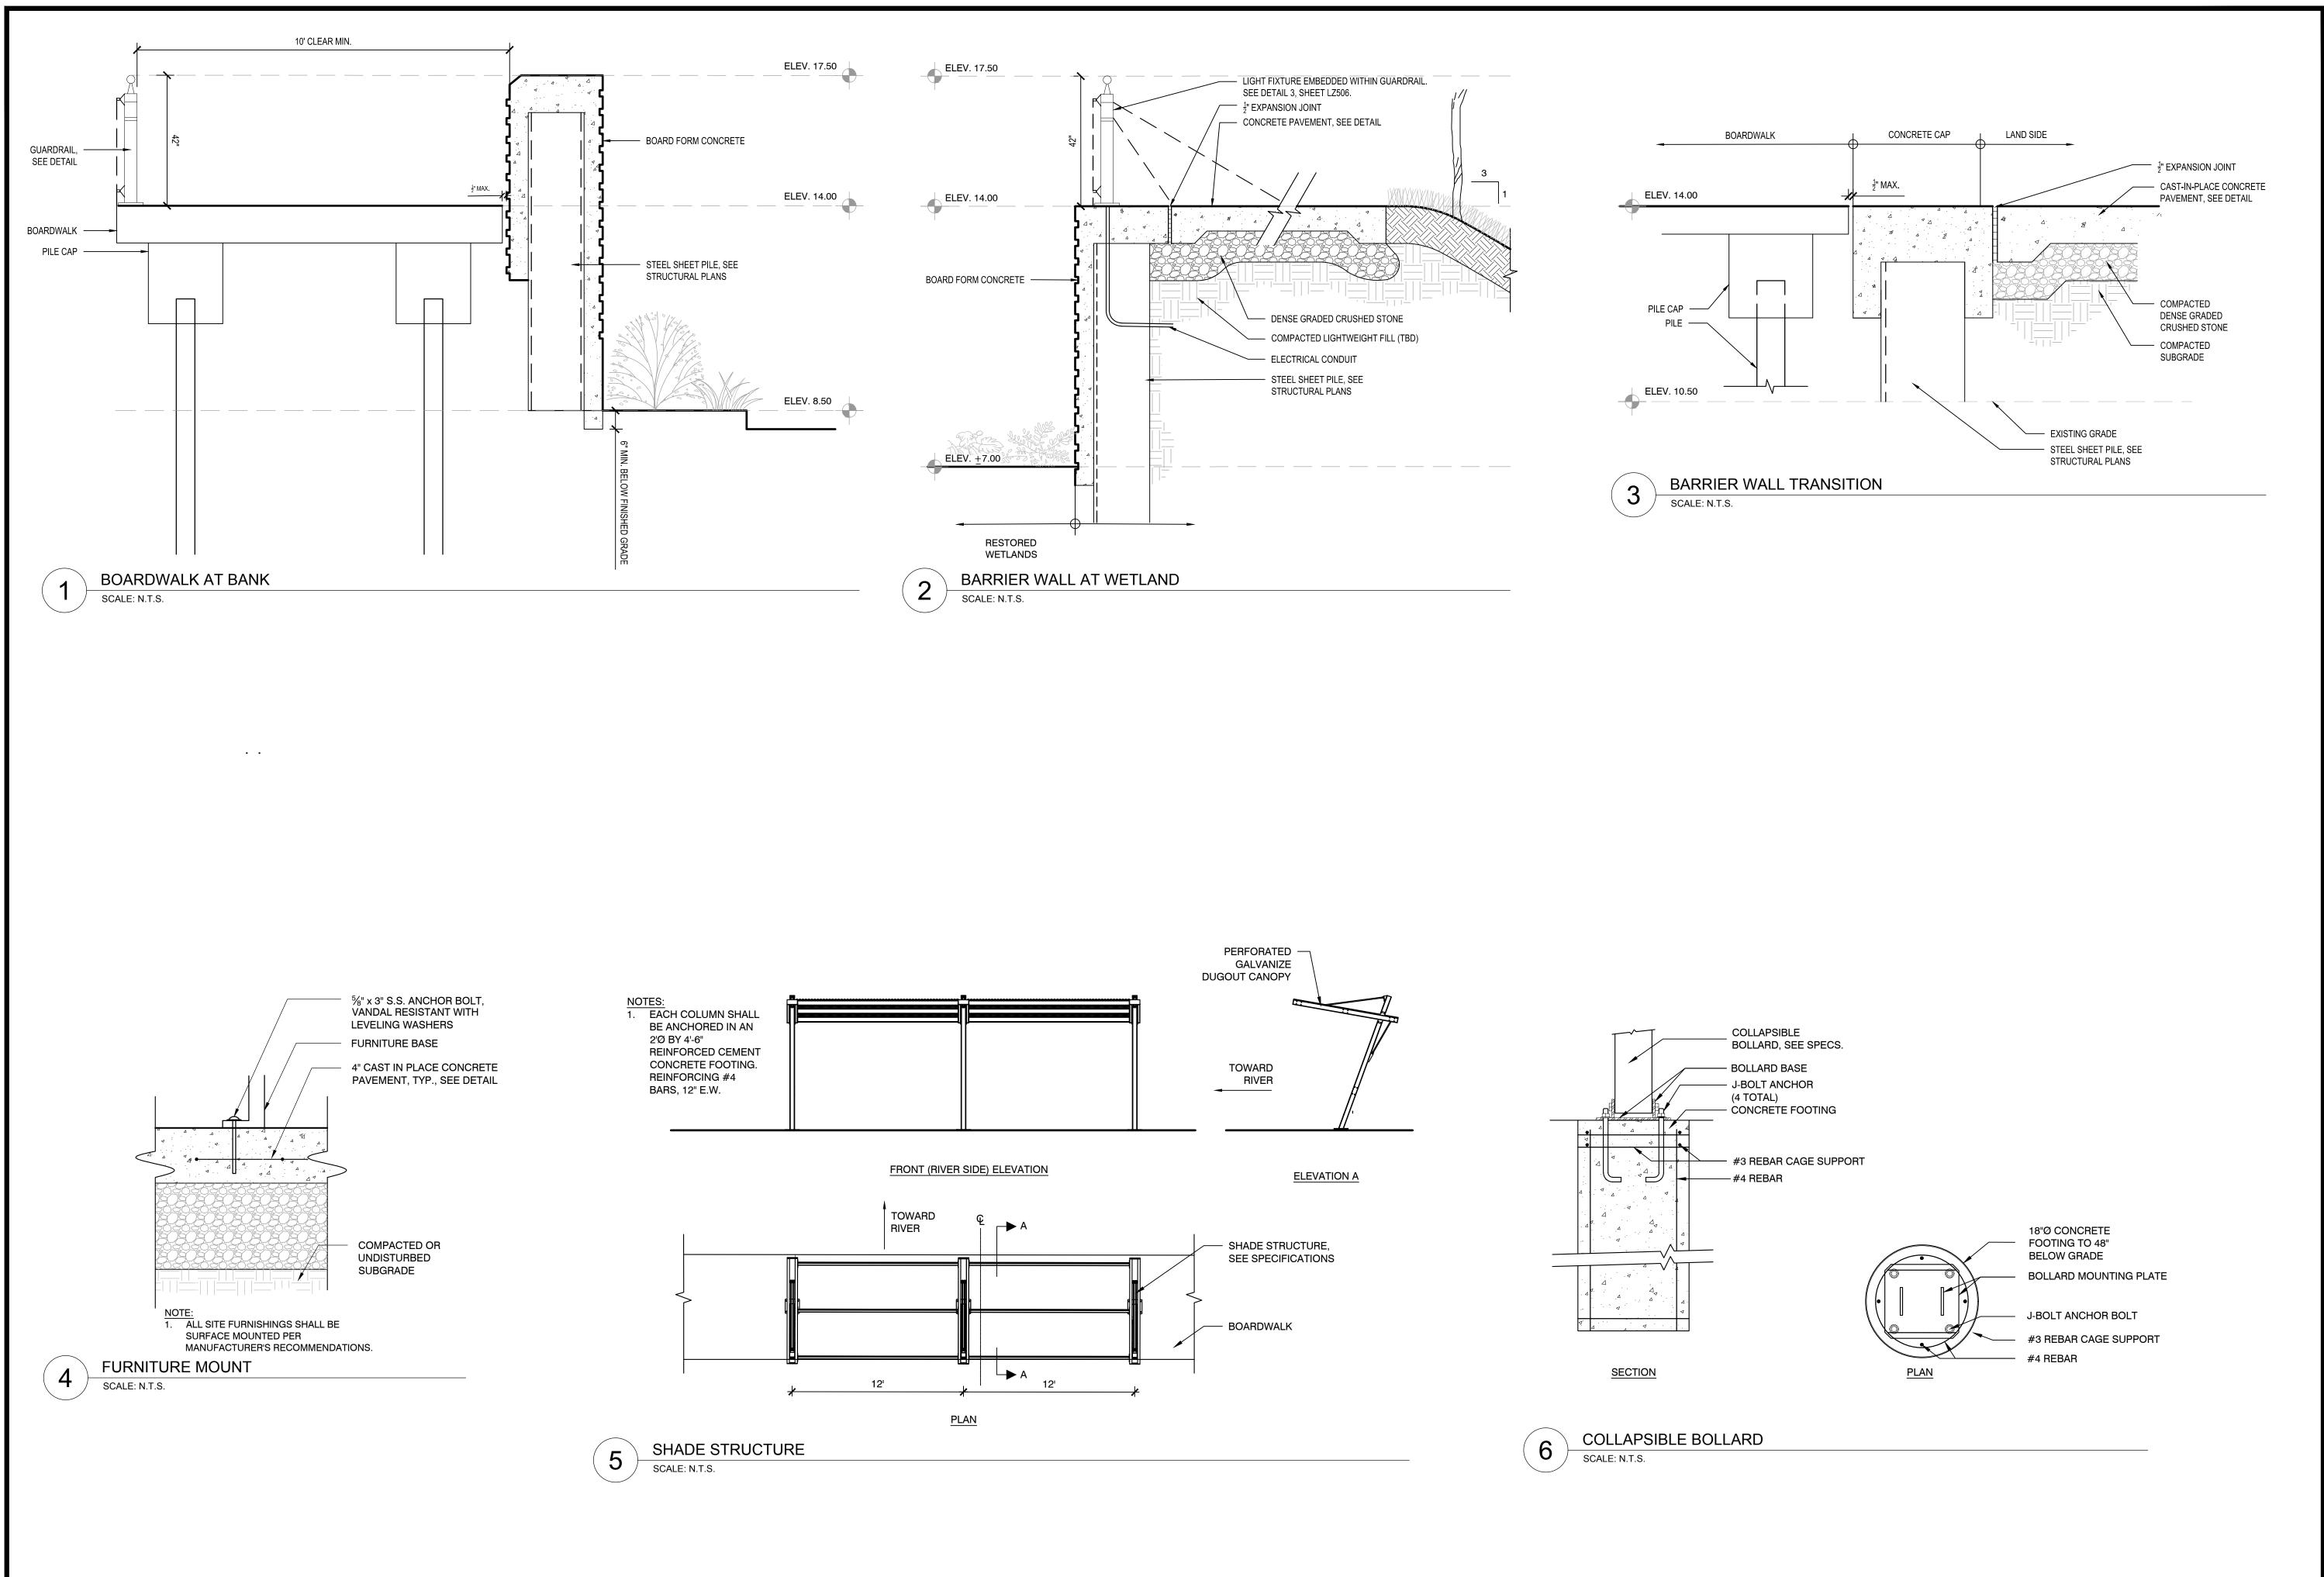
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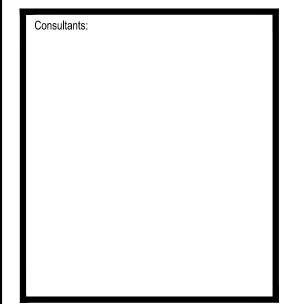
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MATERIALS PLAN 2



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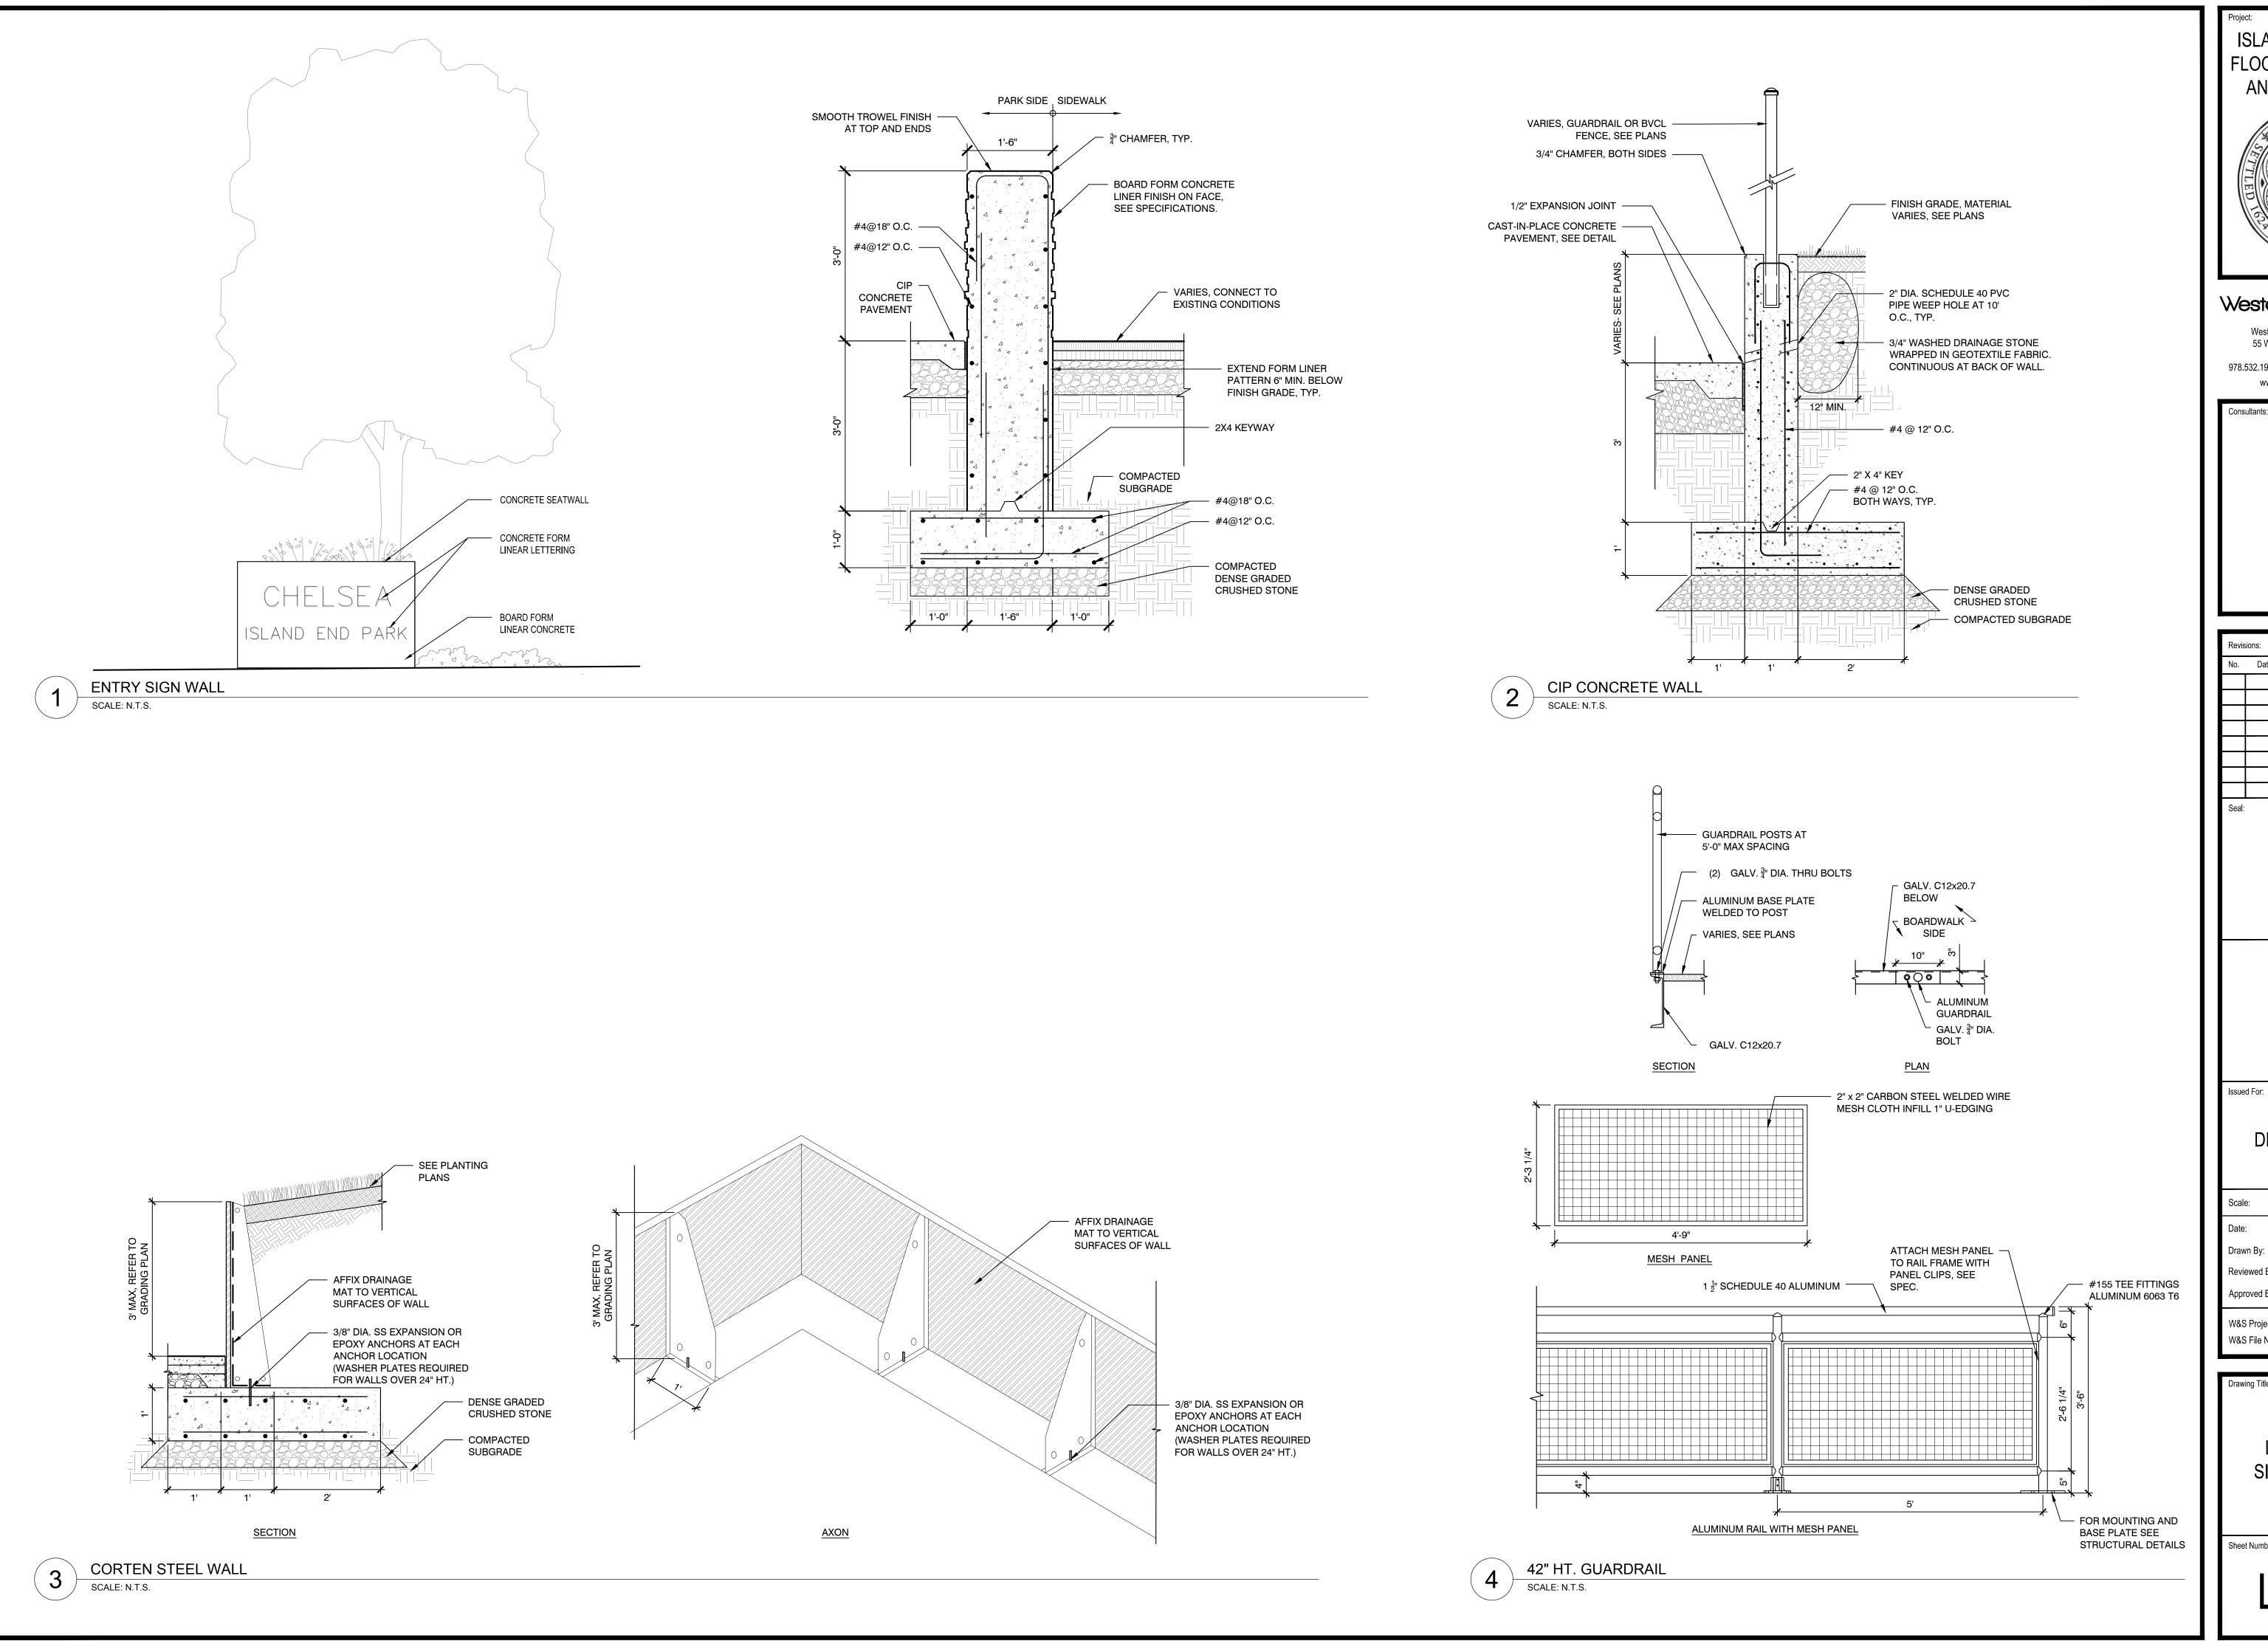



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LANDSCAPE
SITE DETAILS 1


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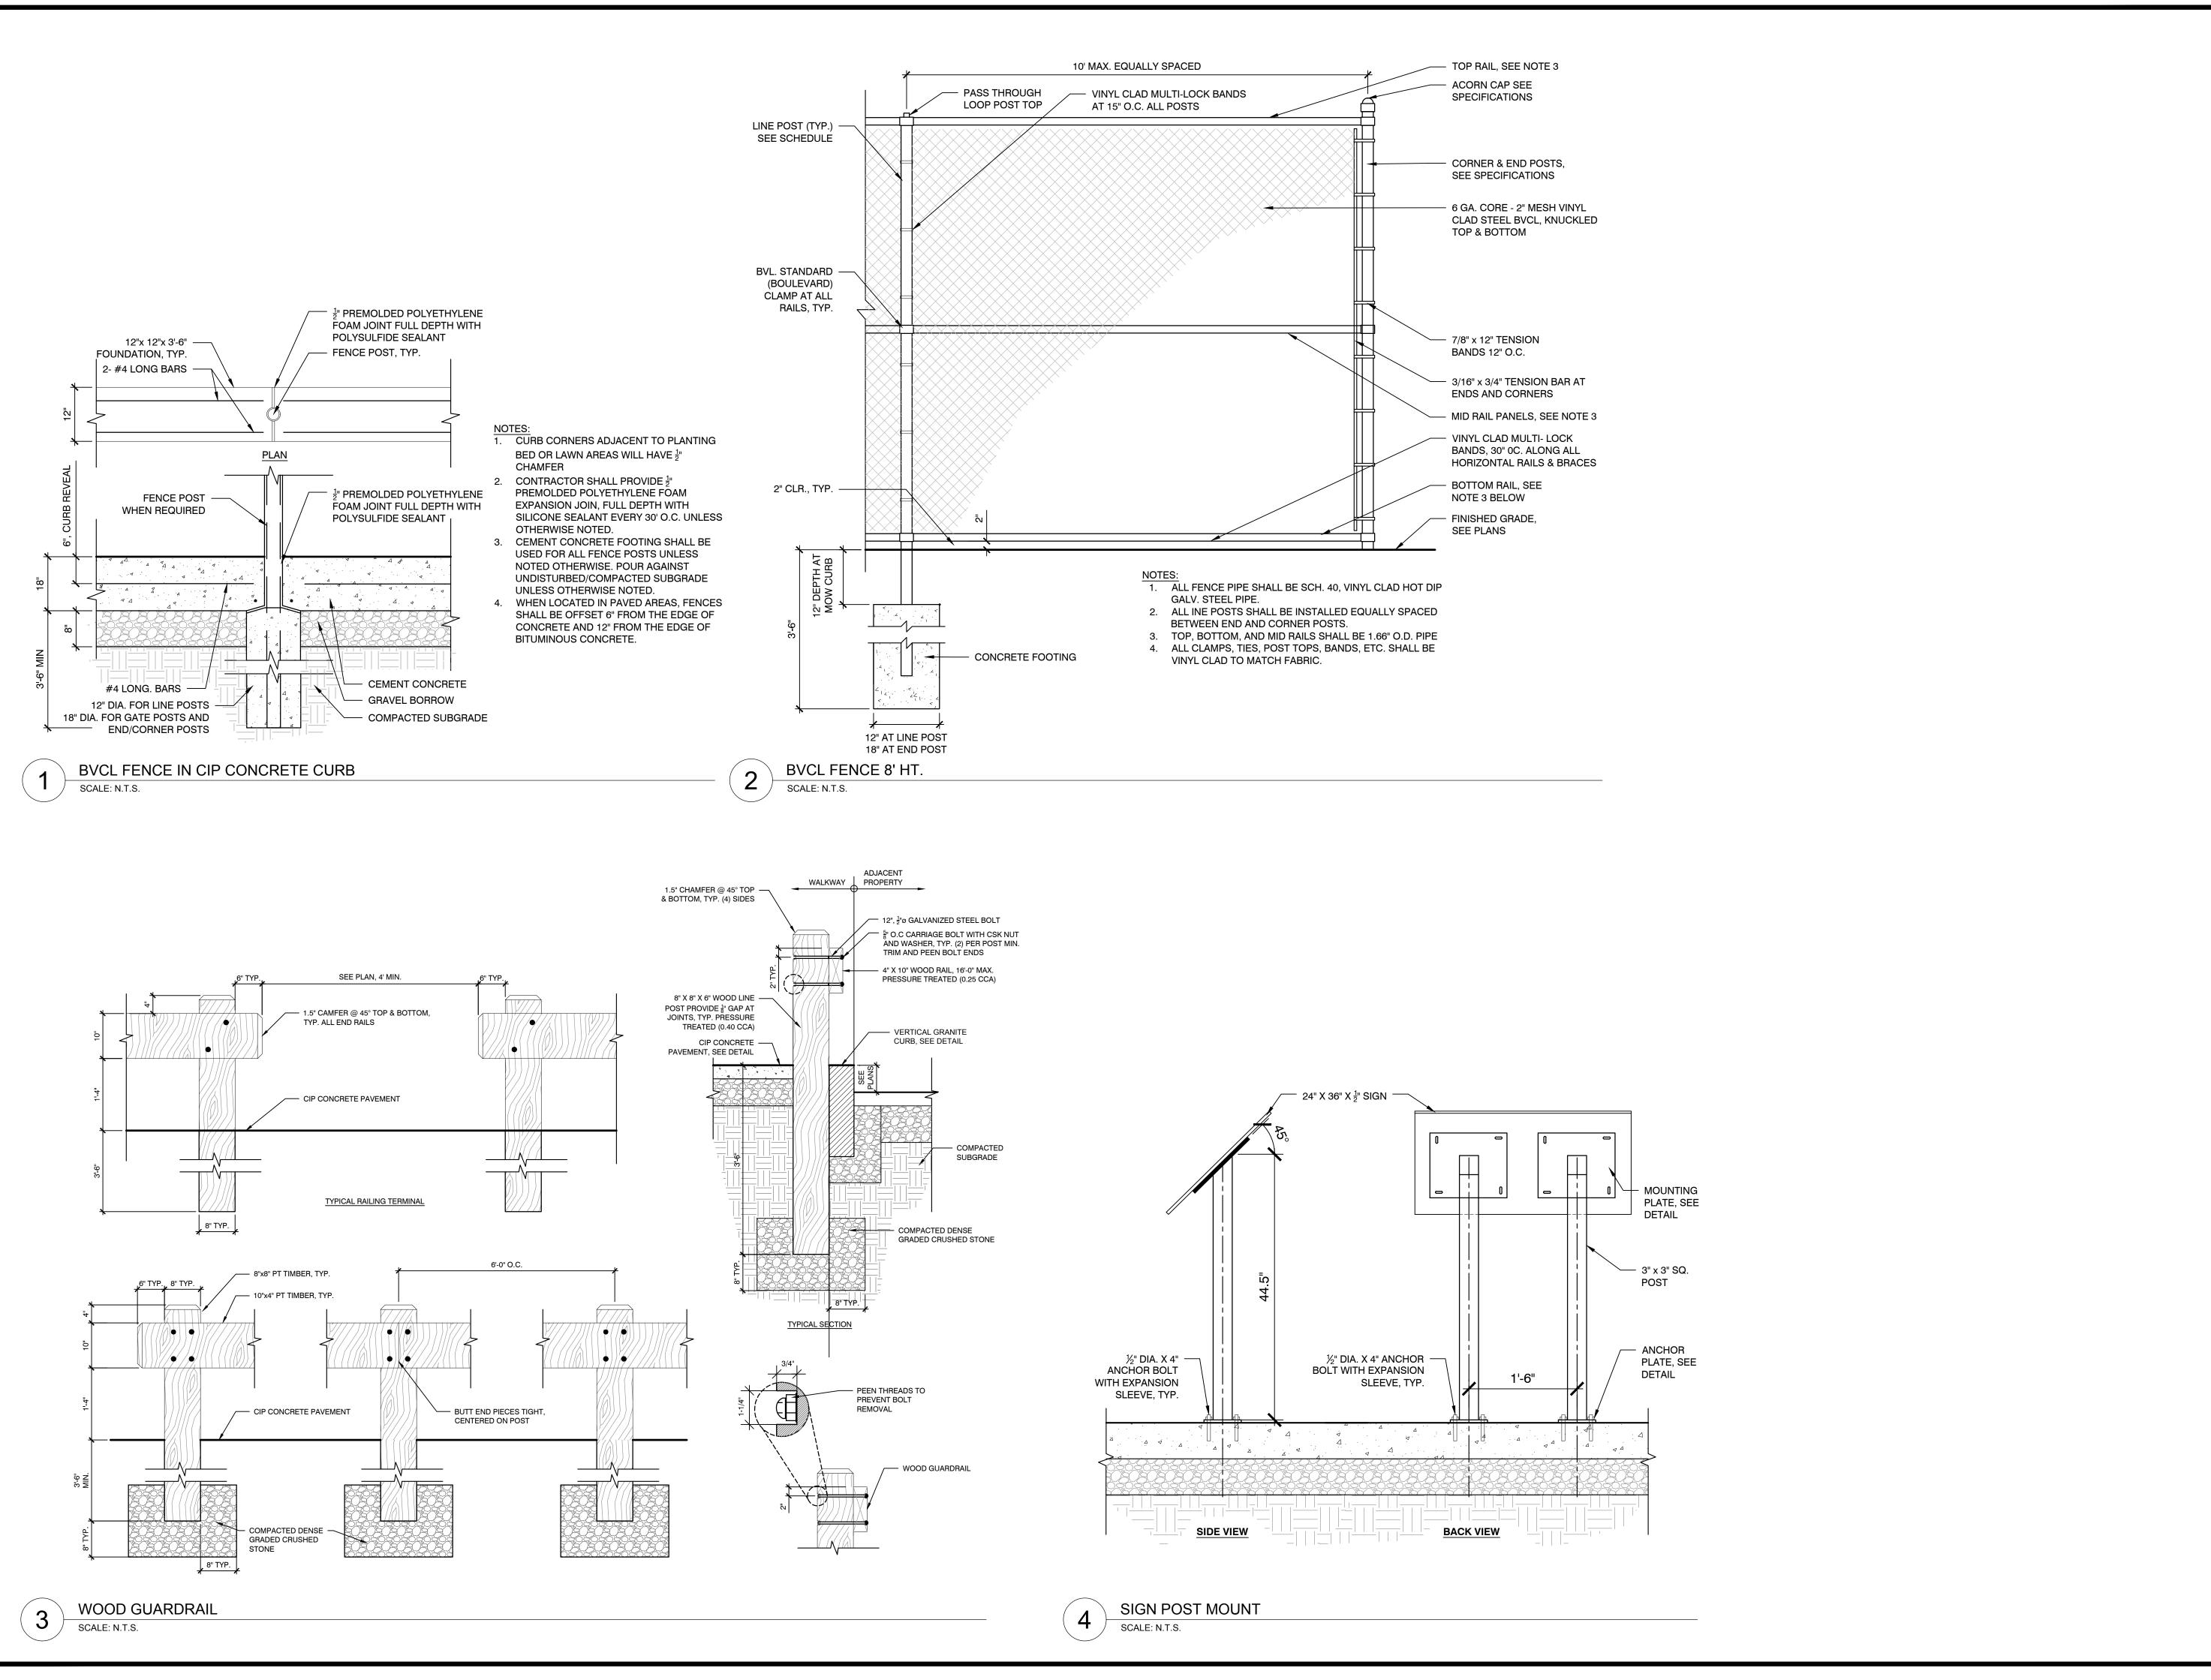
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LANDSCAPE
SITE DETAILS 2


Sheet Number:

LZ502

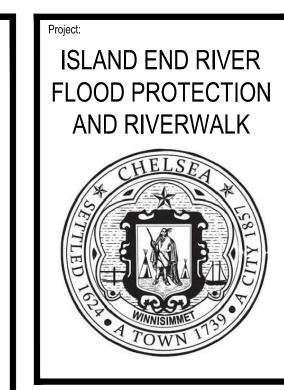

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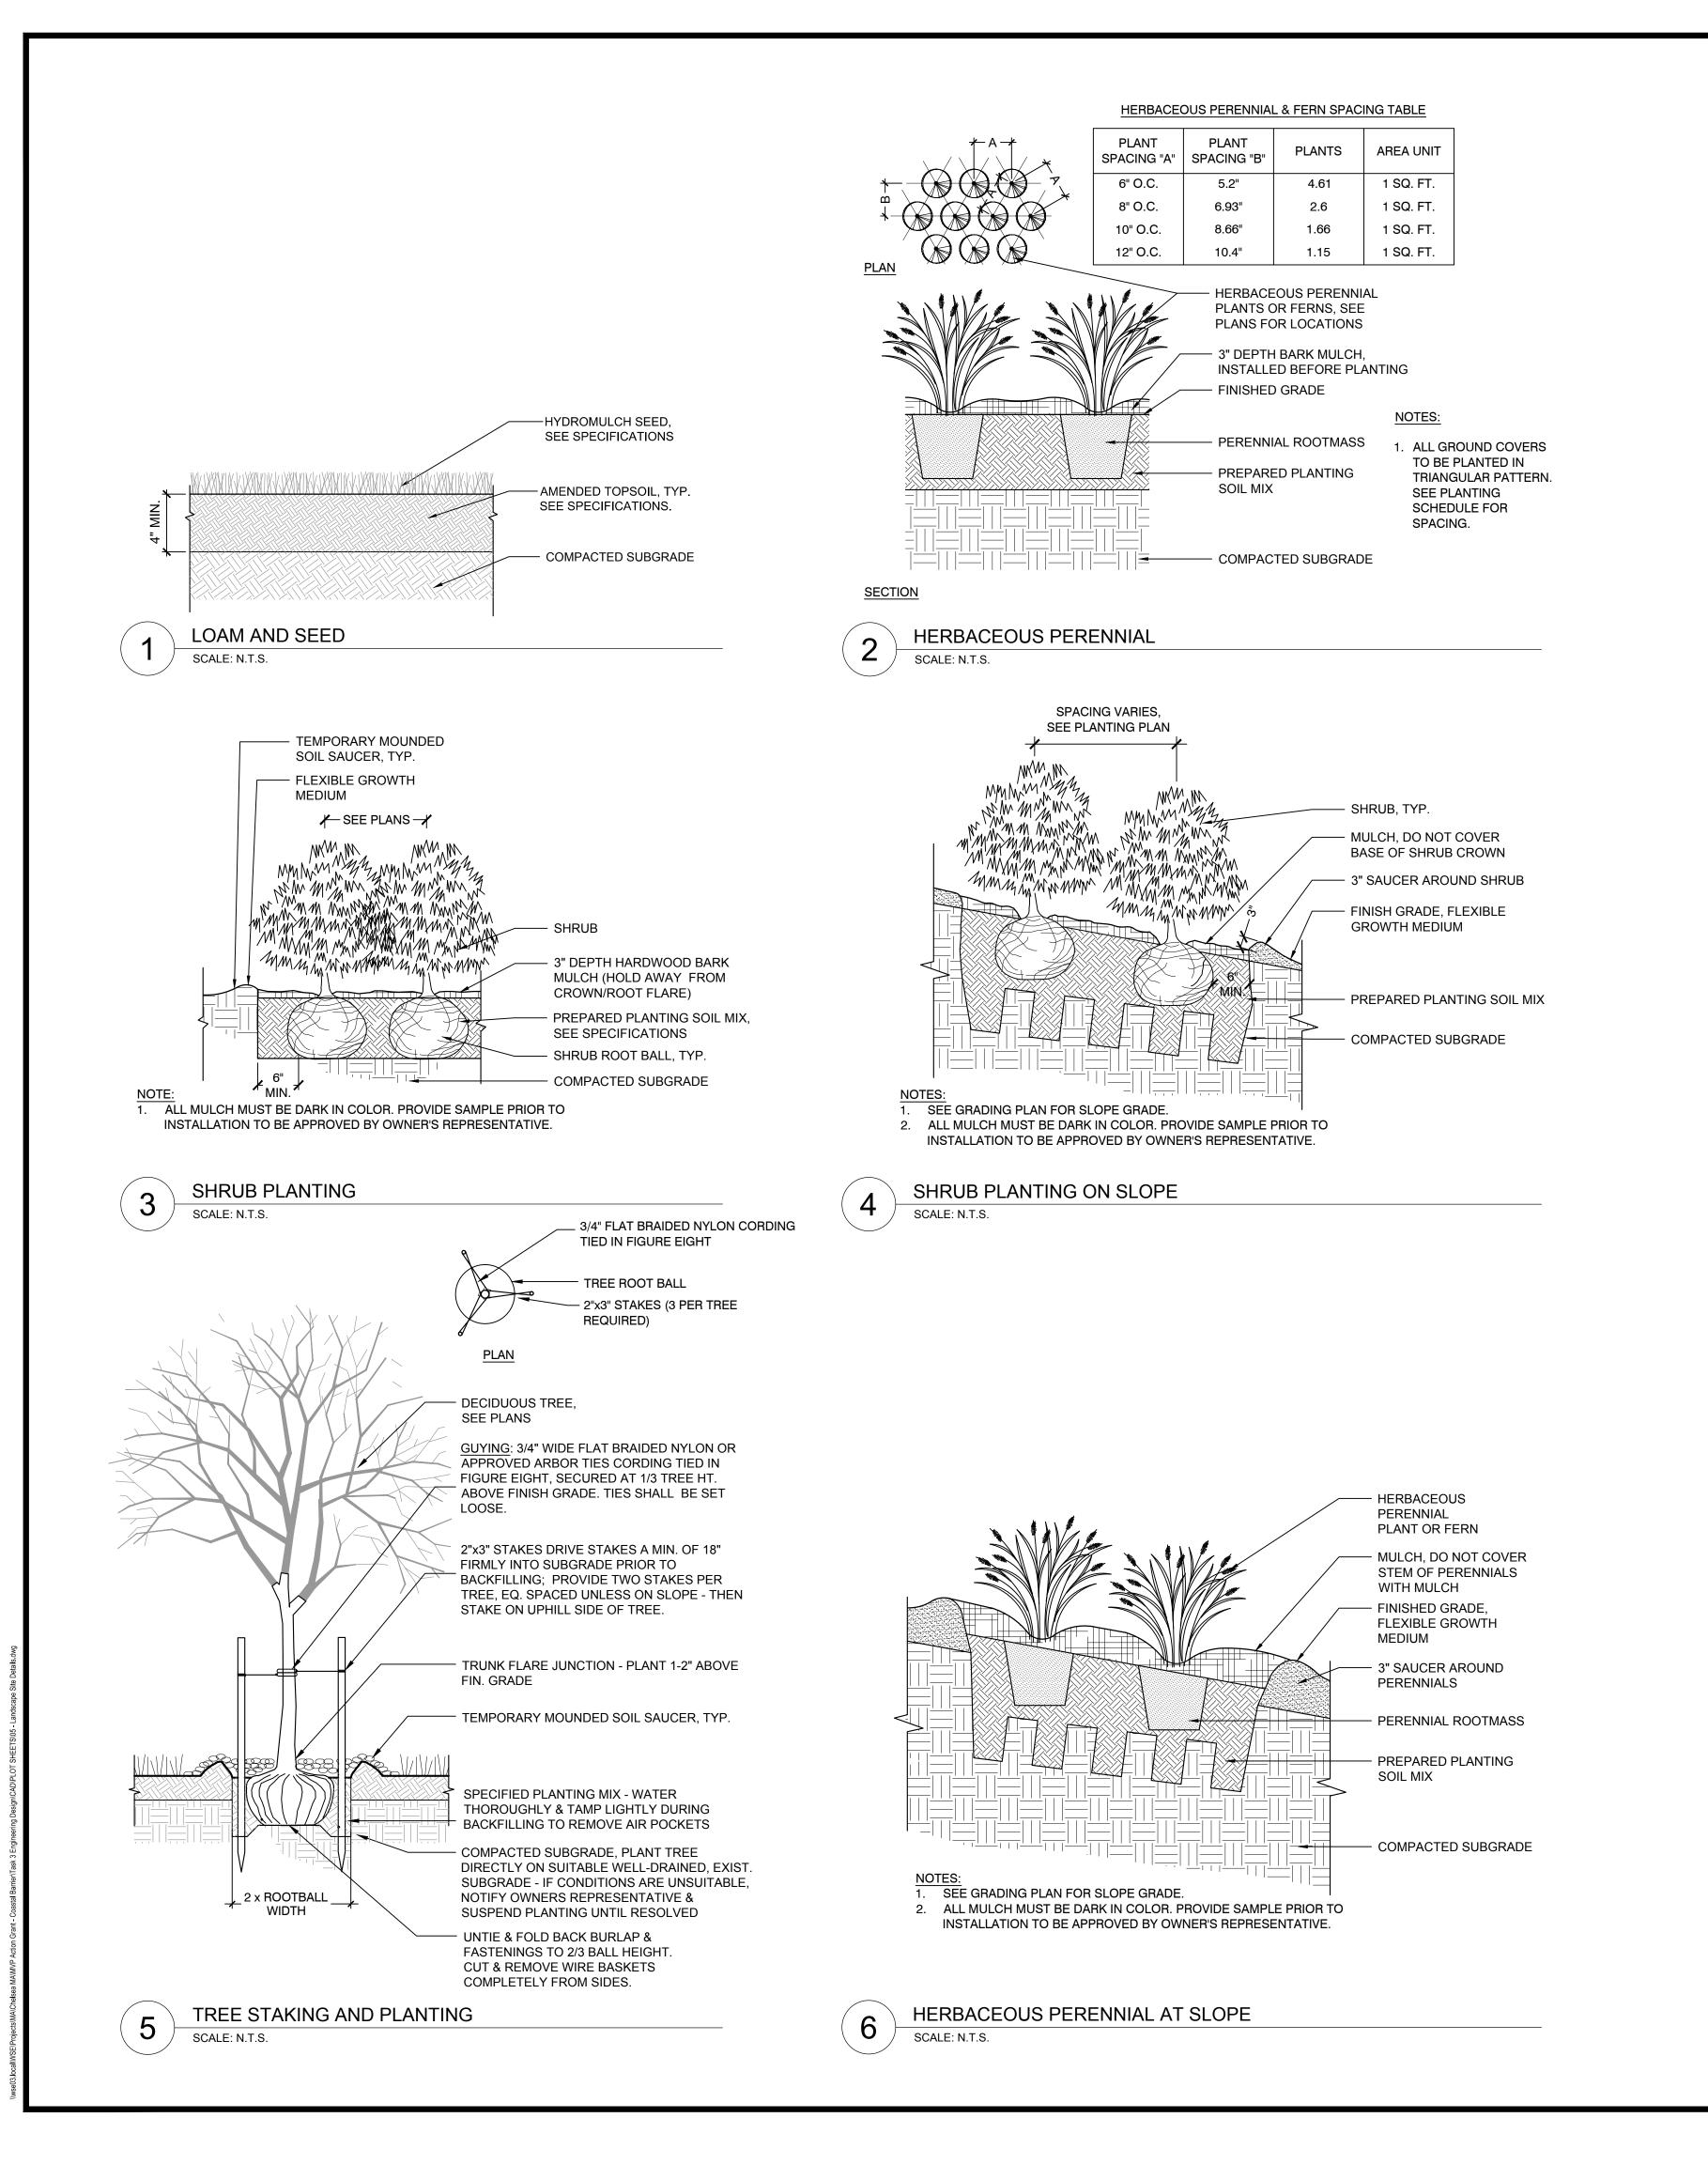
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Date:	JUNE 2021
Drawn By:	FD, LC
Reviewed By:	вк
Approved By:	BWA
W&S Project No.: W&S File No.:	ENG20-0315

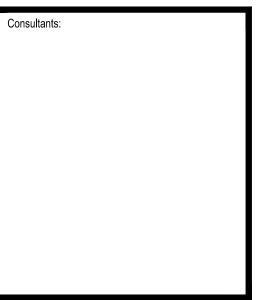
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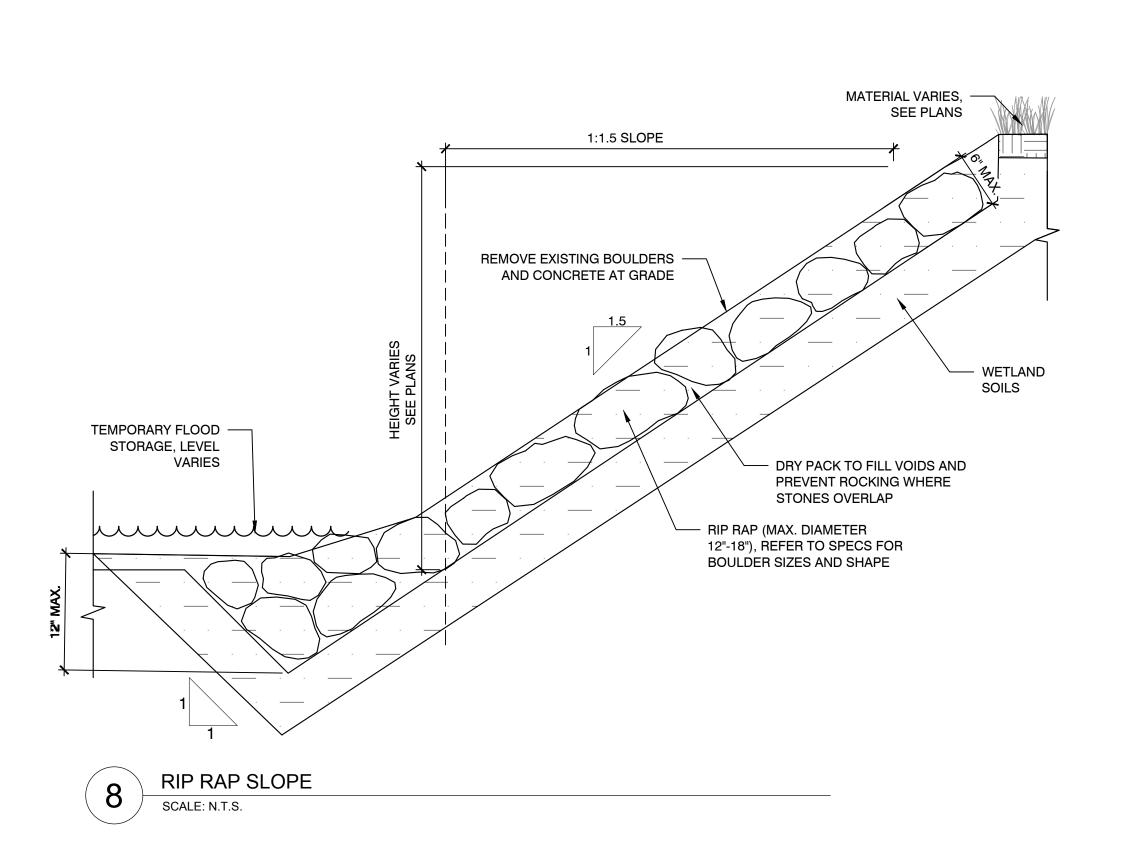
LANDSCAPE SITE DETAILS 3

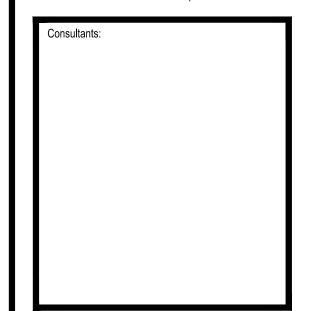Sheet Number:

LZ503






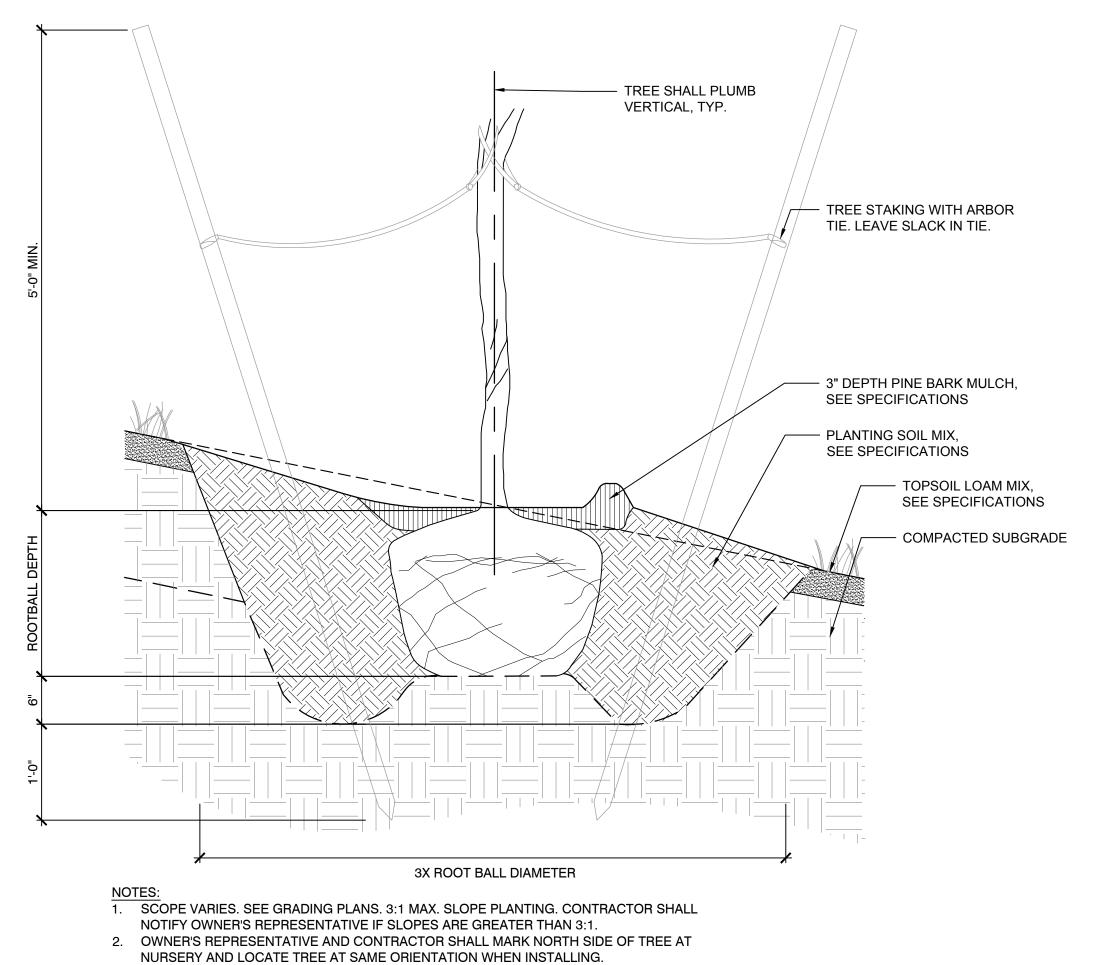

3. REMOVE 2/3 OF BURLAP WRAP AND WIRE BASKET OR TO THE GREATEST EXTENT POSSIBLE WITHOUT COMPROMISING THE STRUCTURAL INTEGRITY OF ROOTBALL


TREE PLANTING ON SLOPE

SCALE: N.T.S.

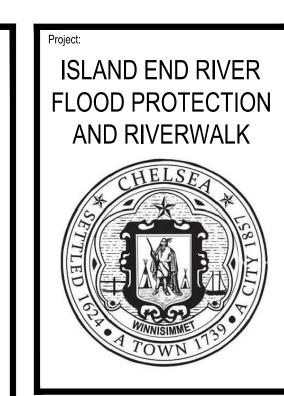

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Date: JUNE 2021

Drawn By: FD, LC

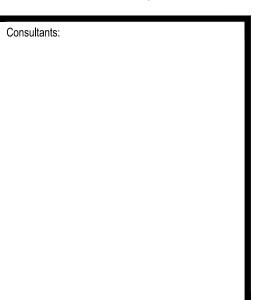Reviewed By: BK

Approved By: BWA

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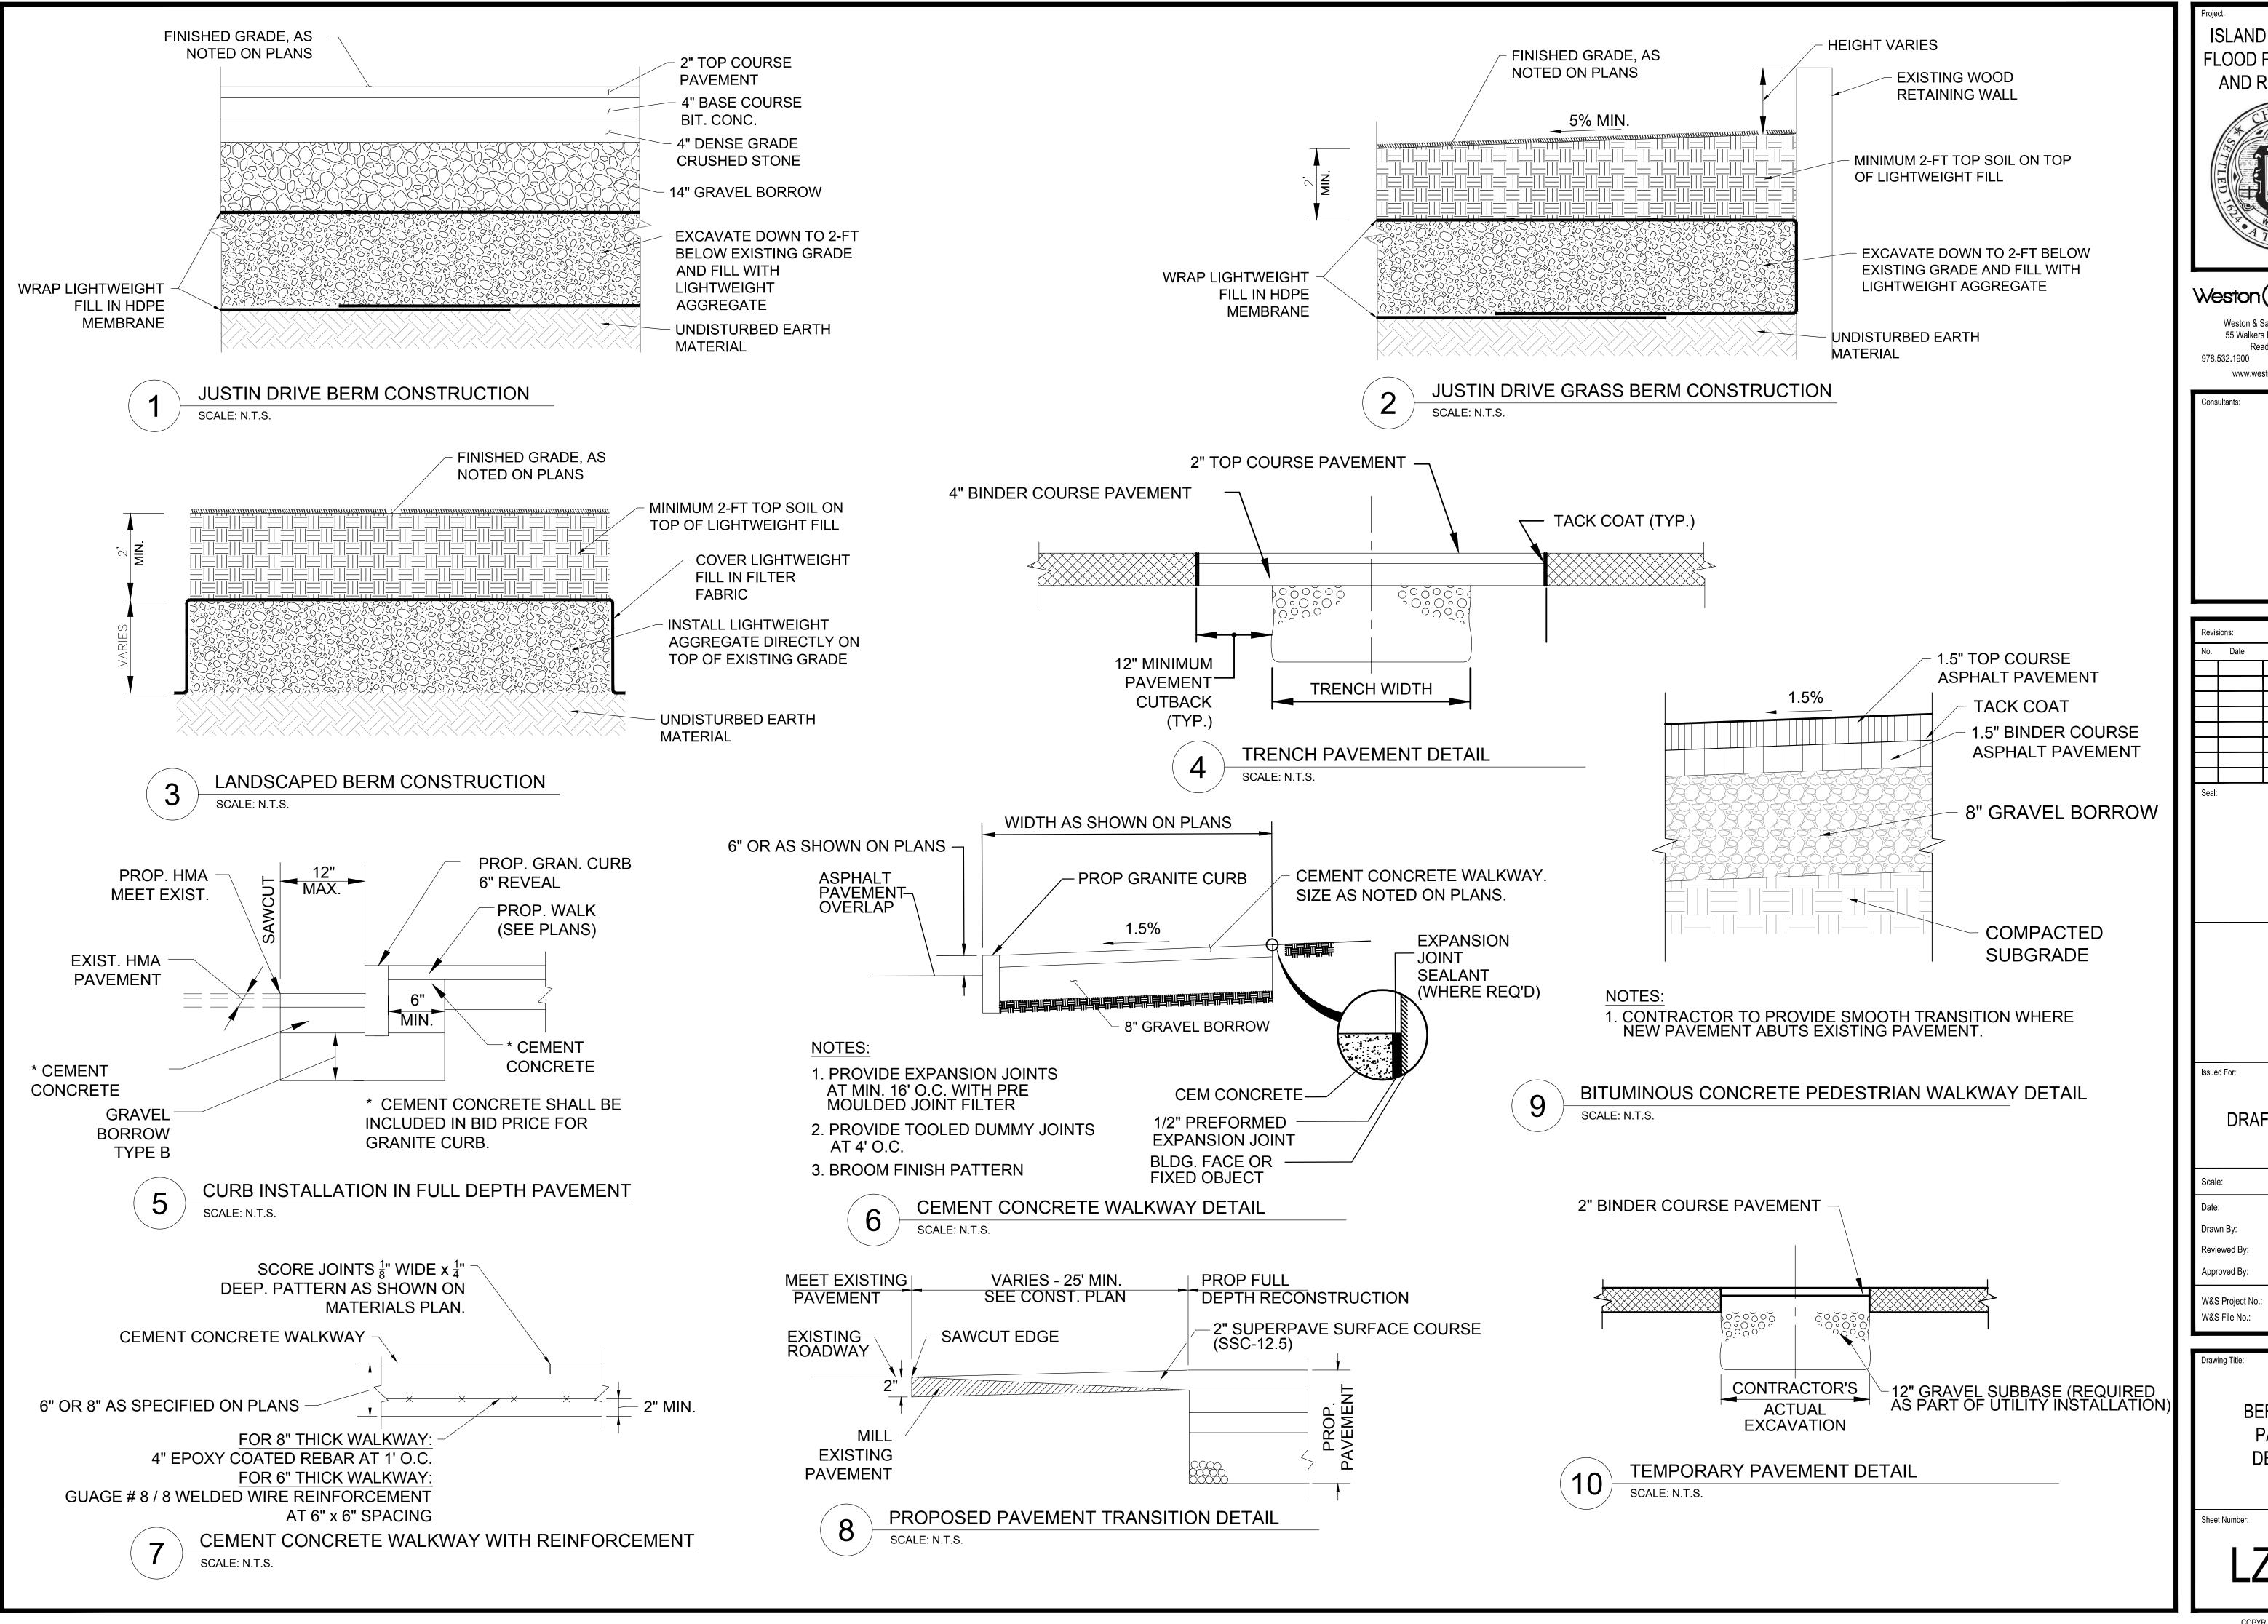
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W&S File No.:

LANDSCAPE SITE DETAILS 4

Sheet Number:

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Drawn By: JBM


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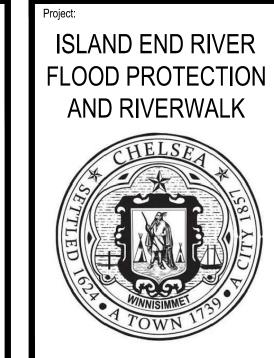
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ENG20-0315


BERM AND PAVING DETAILS

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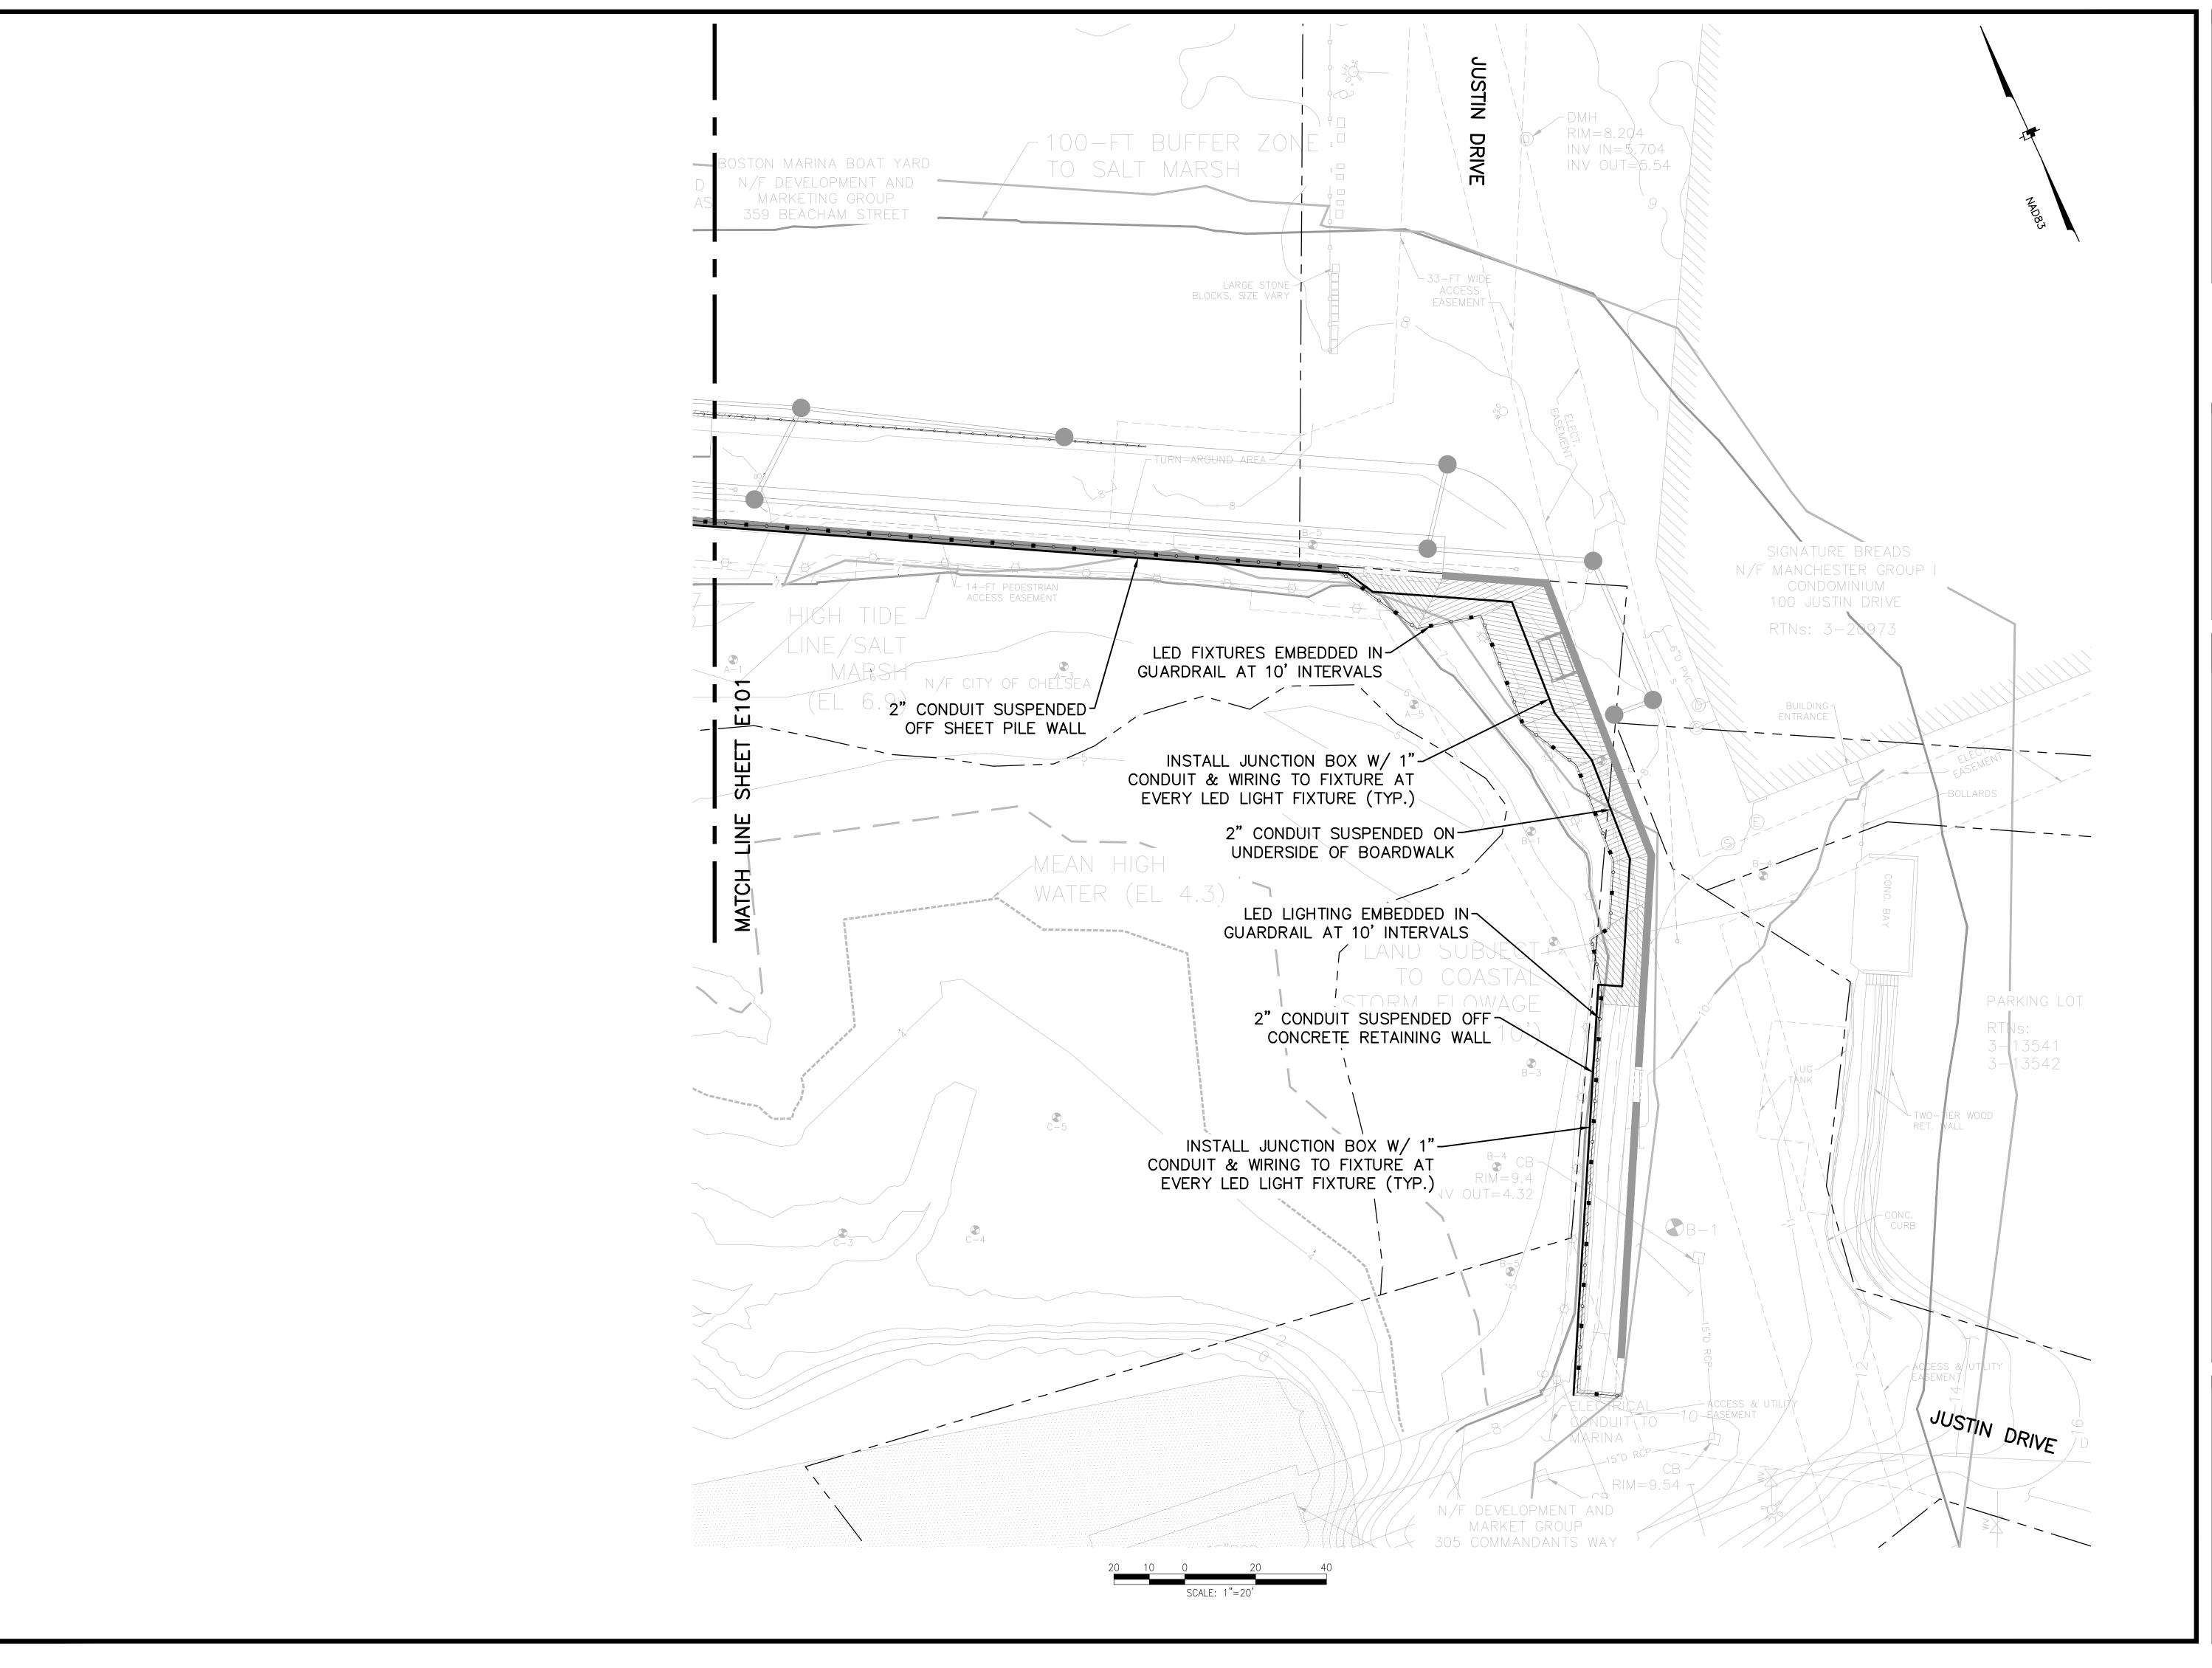
SITE LIGHTING PLAN


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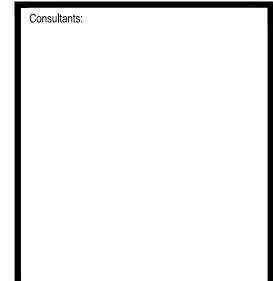
Sheet Number:

E101

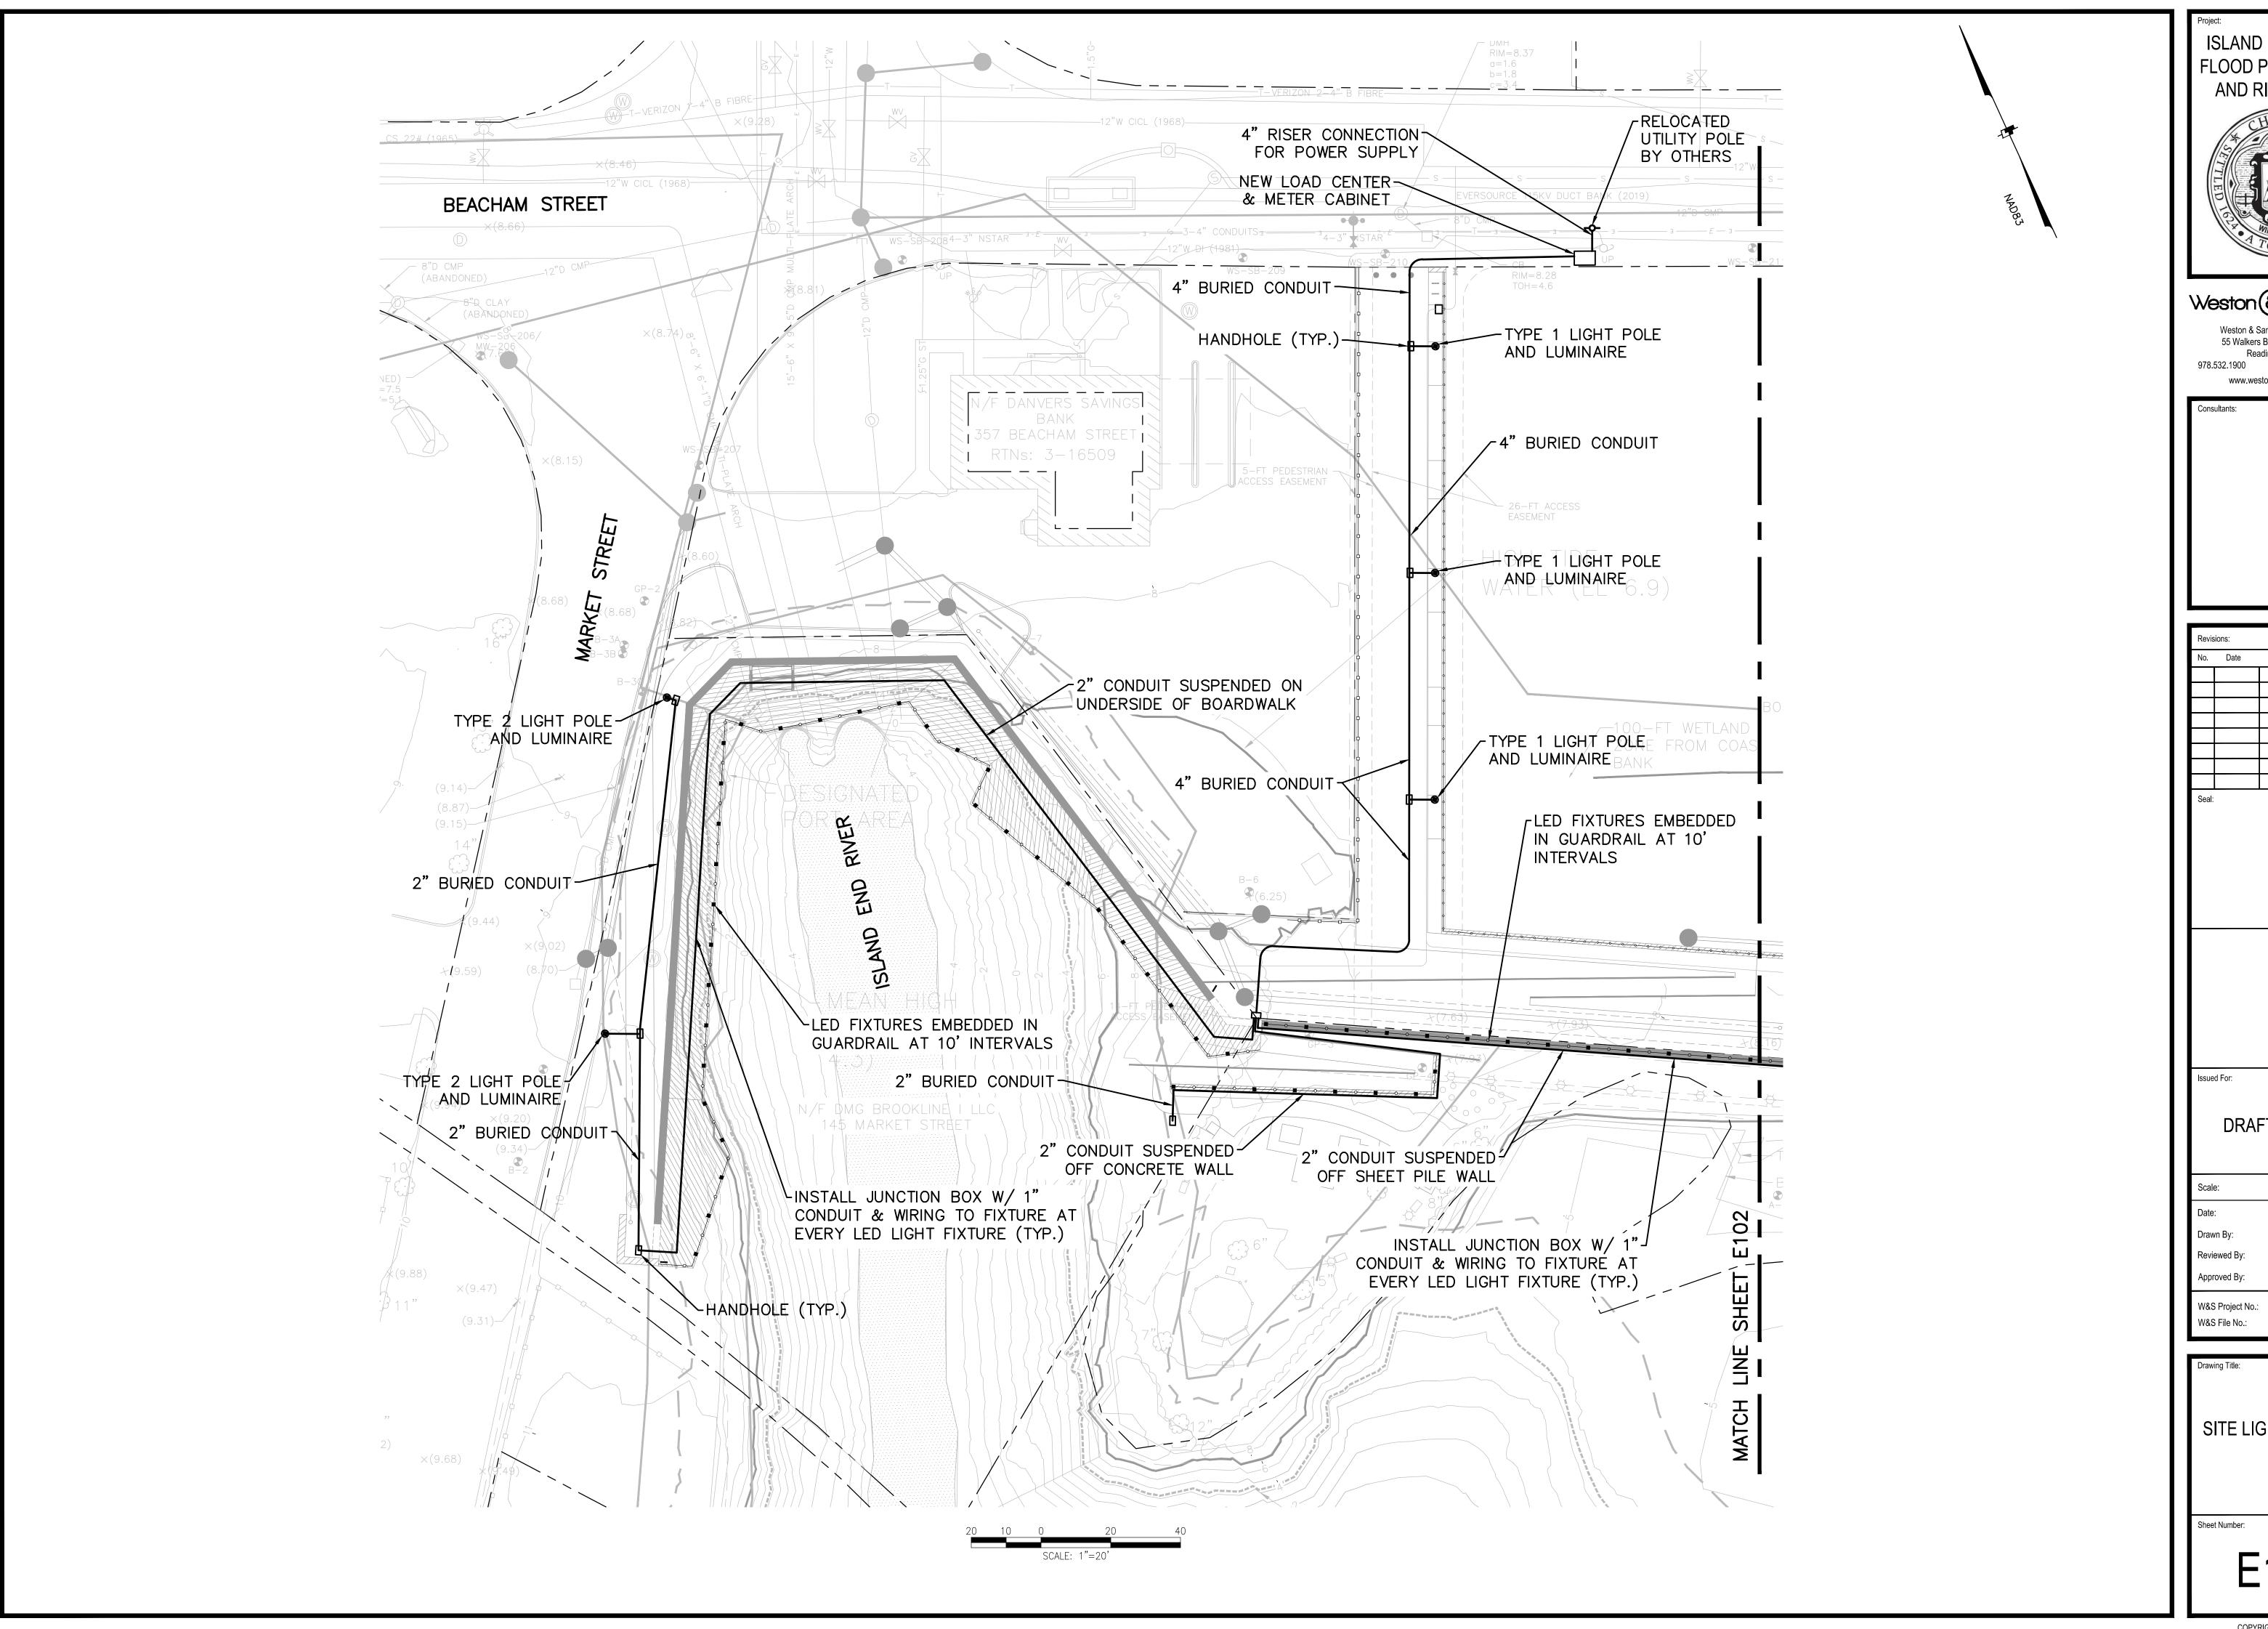

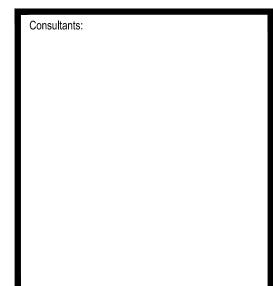

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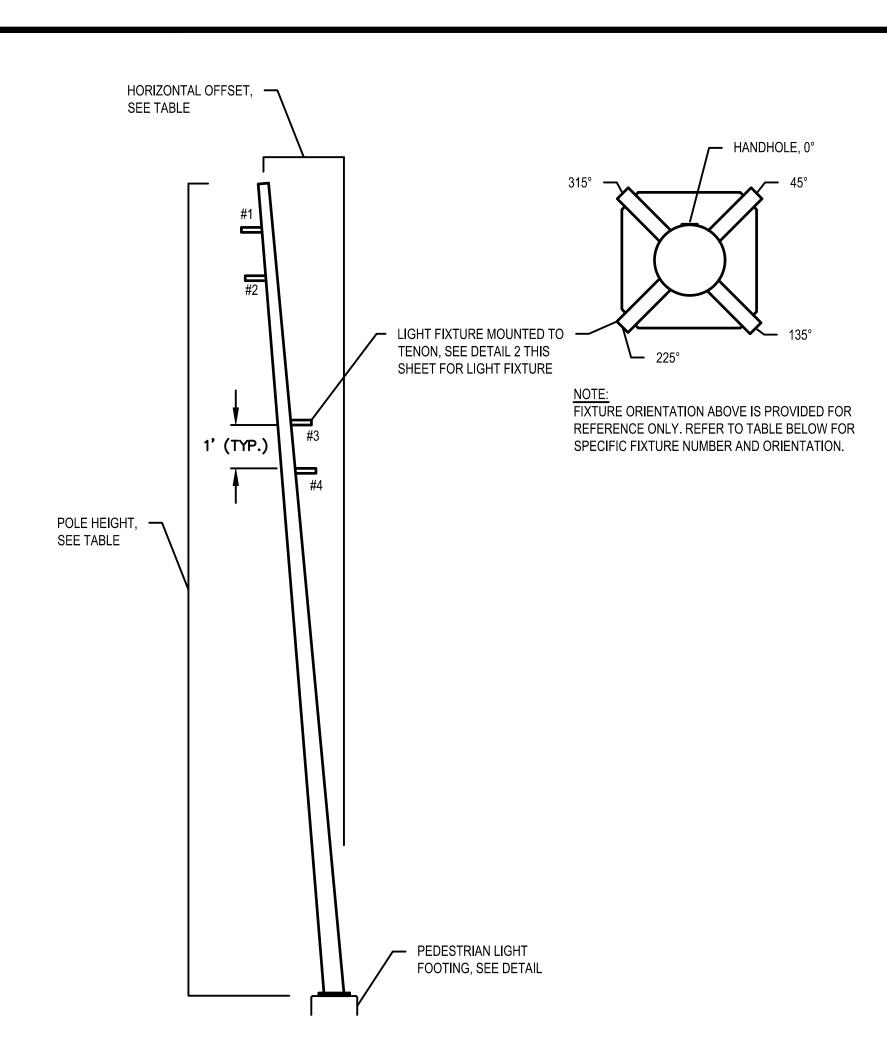
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Reviewed By:	TPC
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W&S Project No.: W&S File No.:	ENG20-0315

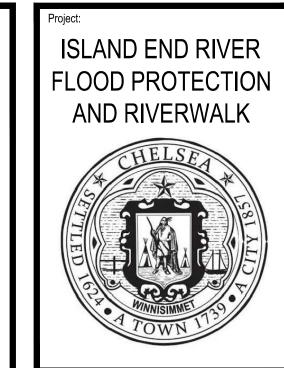Drawing	Title:

SITE LIGHTING PLAN 2

Sheet Number:

E102





LIGHT POLE TYPE	POLE HEIGHT, FT	HORIZONTAL OFFSET, IN	# OF FIXTURES	FIXTURE ORIENTATION
TYPE 1	18	19	2	#1, 135°; #2, 225°
TYPE 2	24	24	4	#1, 135°; #2, 225°; #3, 45°; #4, 315°


- 1. LIGHT POLE SHALL BE REED TILTED ARCHITECTURAL STEEL POLES, AS MANUFACTURED BY STRUCTURA, OR APPROVED EQUAL.
- 2. LIGHT POLES SHALL BE CONSTRUCTED OF ROLLED GALVANIZED STEEL AND SHALL BE
- POLYESTER POWDER COAT PAINTED.
- 3. ALL LIGHT POLE FIXTURES SHALL BE MOUNTED TO SPECIFIED TENON, EACH WITH DIMENSIONS SUITABLE FOR INSTALLATION OF LIGHT FIXTURE.
- 4. LIGHT FIXTURE ORIENTATION SHALL BE AS SPECIFIED IN THE TABLE ABOVE.

#### PEDESTRIAN LIGHT POLE

SCALE: N.T.S.

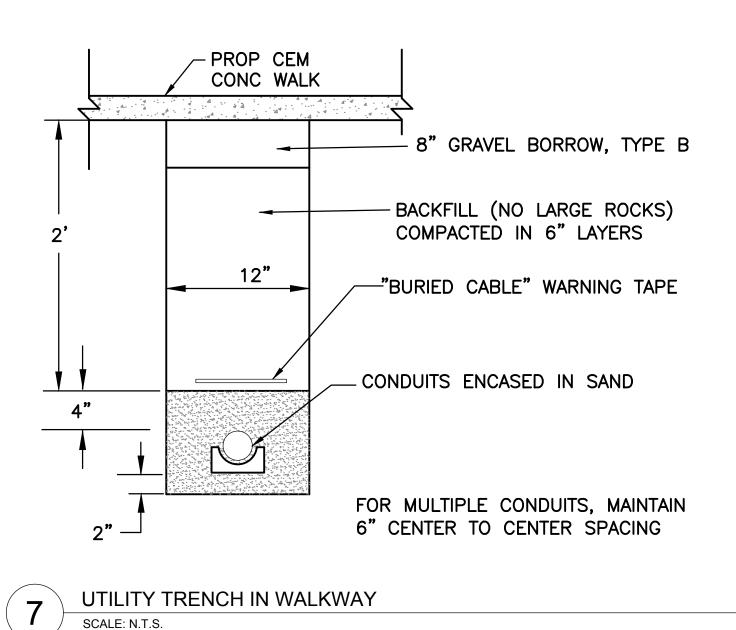


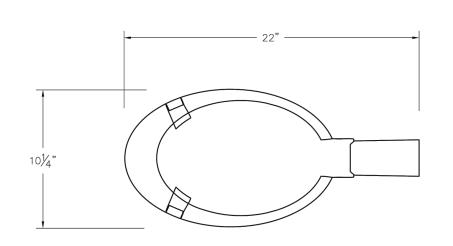

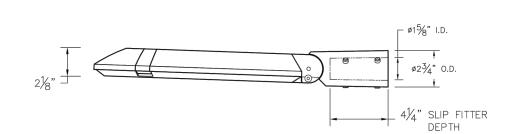


- NOTES:

  1. LIGHT FIXTURES SHALL BE LED DAVIT ARM LUMINAIRE WITH ASYMMETRIC WIDE BEAM
- LIGHT DISTRIBUTION. 2. FIXTURES SHALL BE BEGA LUMINAIRE #77 897, OR APPROVED EQUAL.

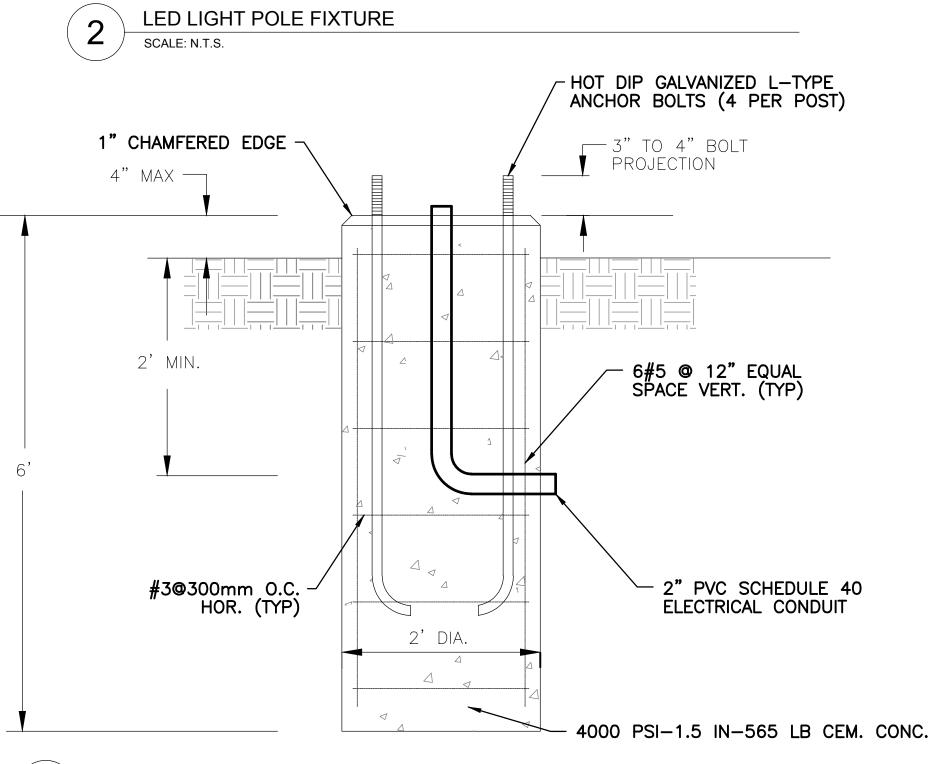




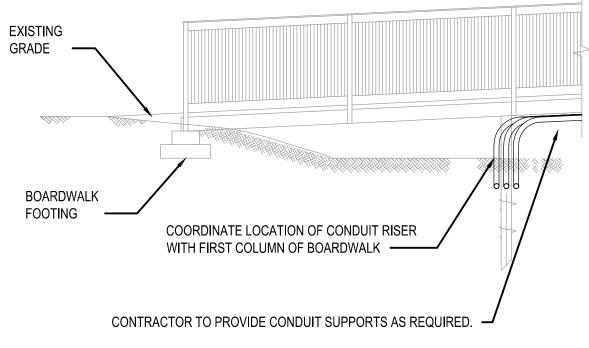


SCALE: N.T.S.

RISER AT BOARDWALK TRANSITION

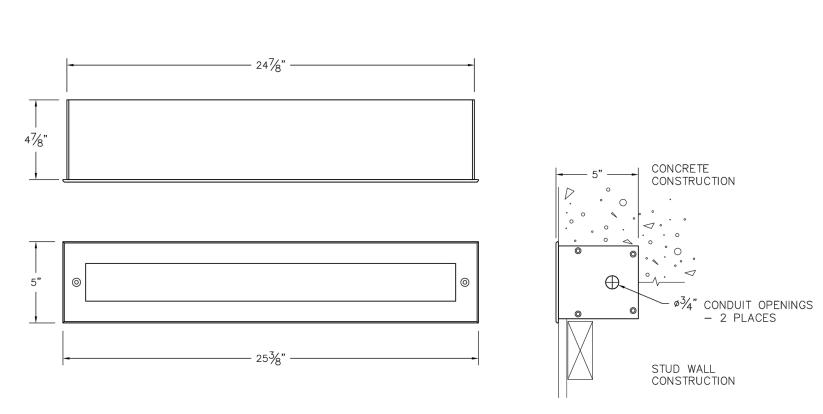


LIGHT FIXTURE SHALL BE STAINLESS STEEL RECESSED LED WALL LUMINAIRE WITH


- UNSHIELDED LIGHT DISTRIBUTION.
  2. FIXTURES SHALL BE BEGA LUMINAIRE #24 104, OR APPROVED EQUAL.
- GUARDRAIL EMBEDDED LED LIGHT FIXTURE SCALE: N.T.S.

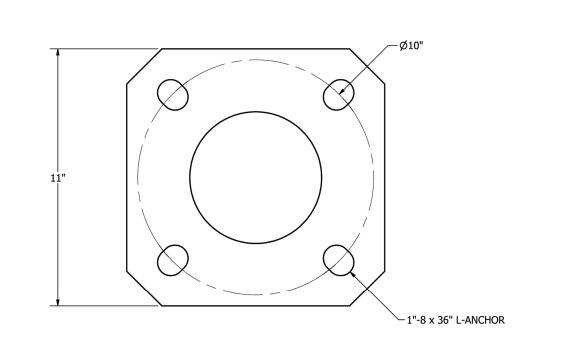

PEDESTRIAN LIGHT POLE ANCHOR BOLT DETAIL SCALE: N.T.S.

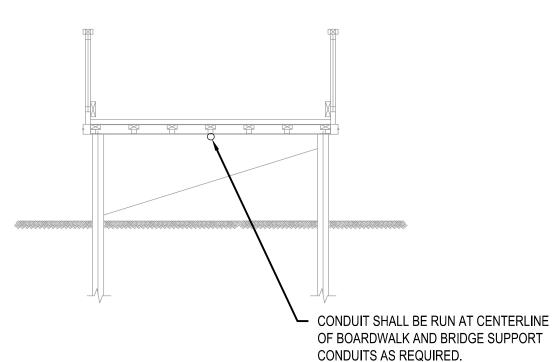

TYPICAL SUSPENDED CONDUIT SECTION AT BOARDWALK 6

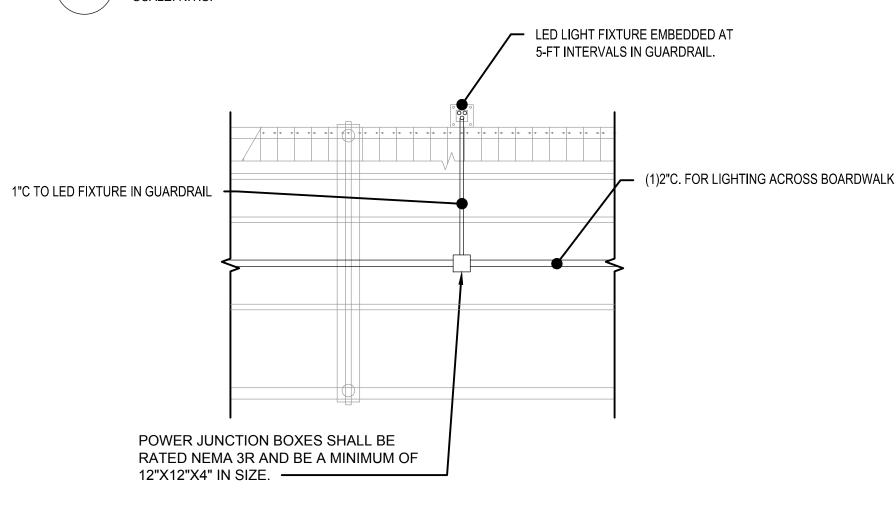


TYPICAL CONDUIT ROUTING AT LIGHT FIXTURE SCALE: N.T.S.

ISLAND END RIVER FLOOD PROTECTION AND RIVERWALK

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Description

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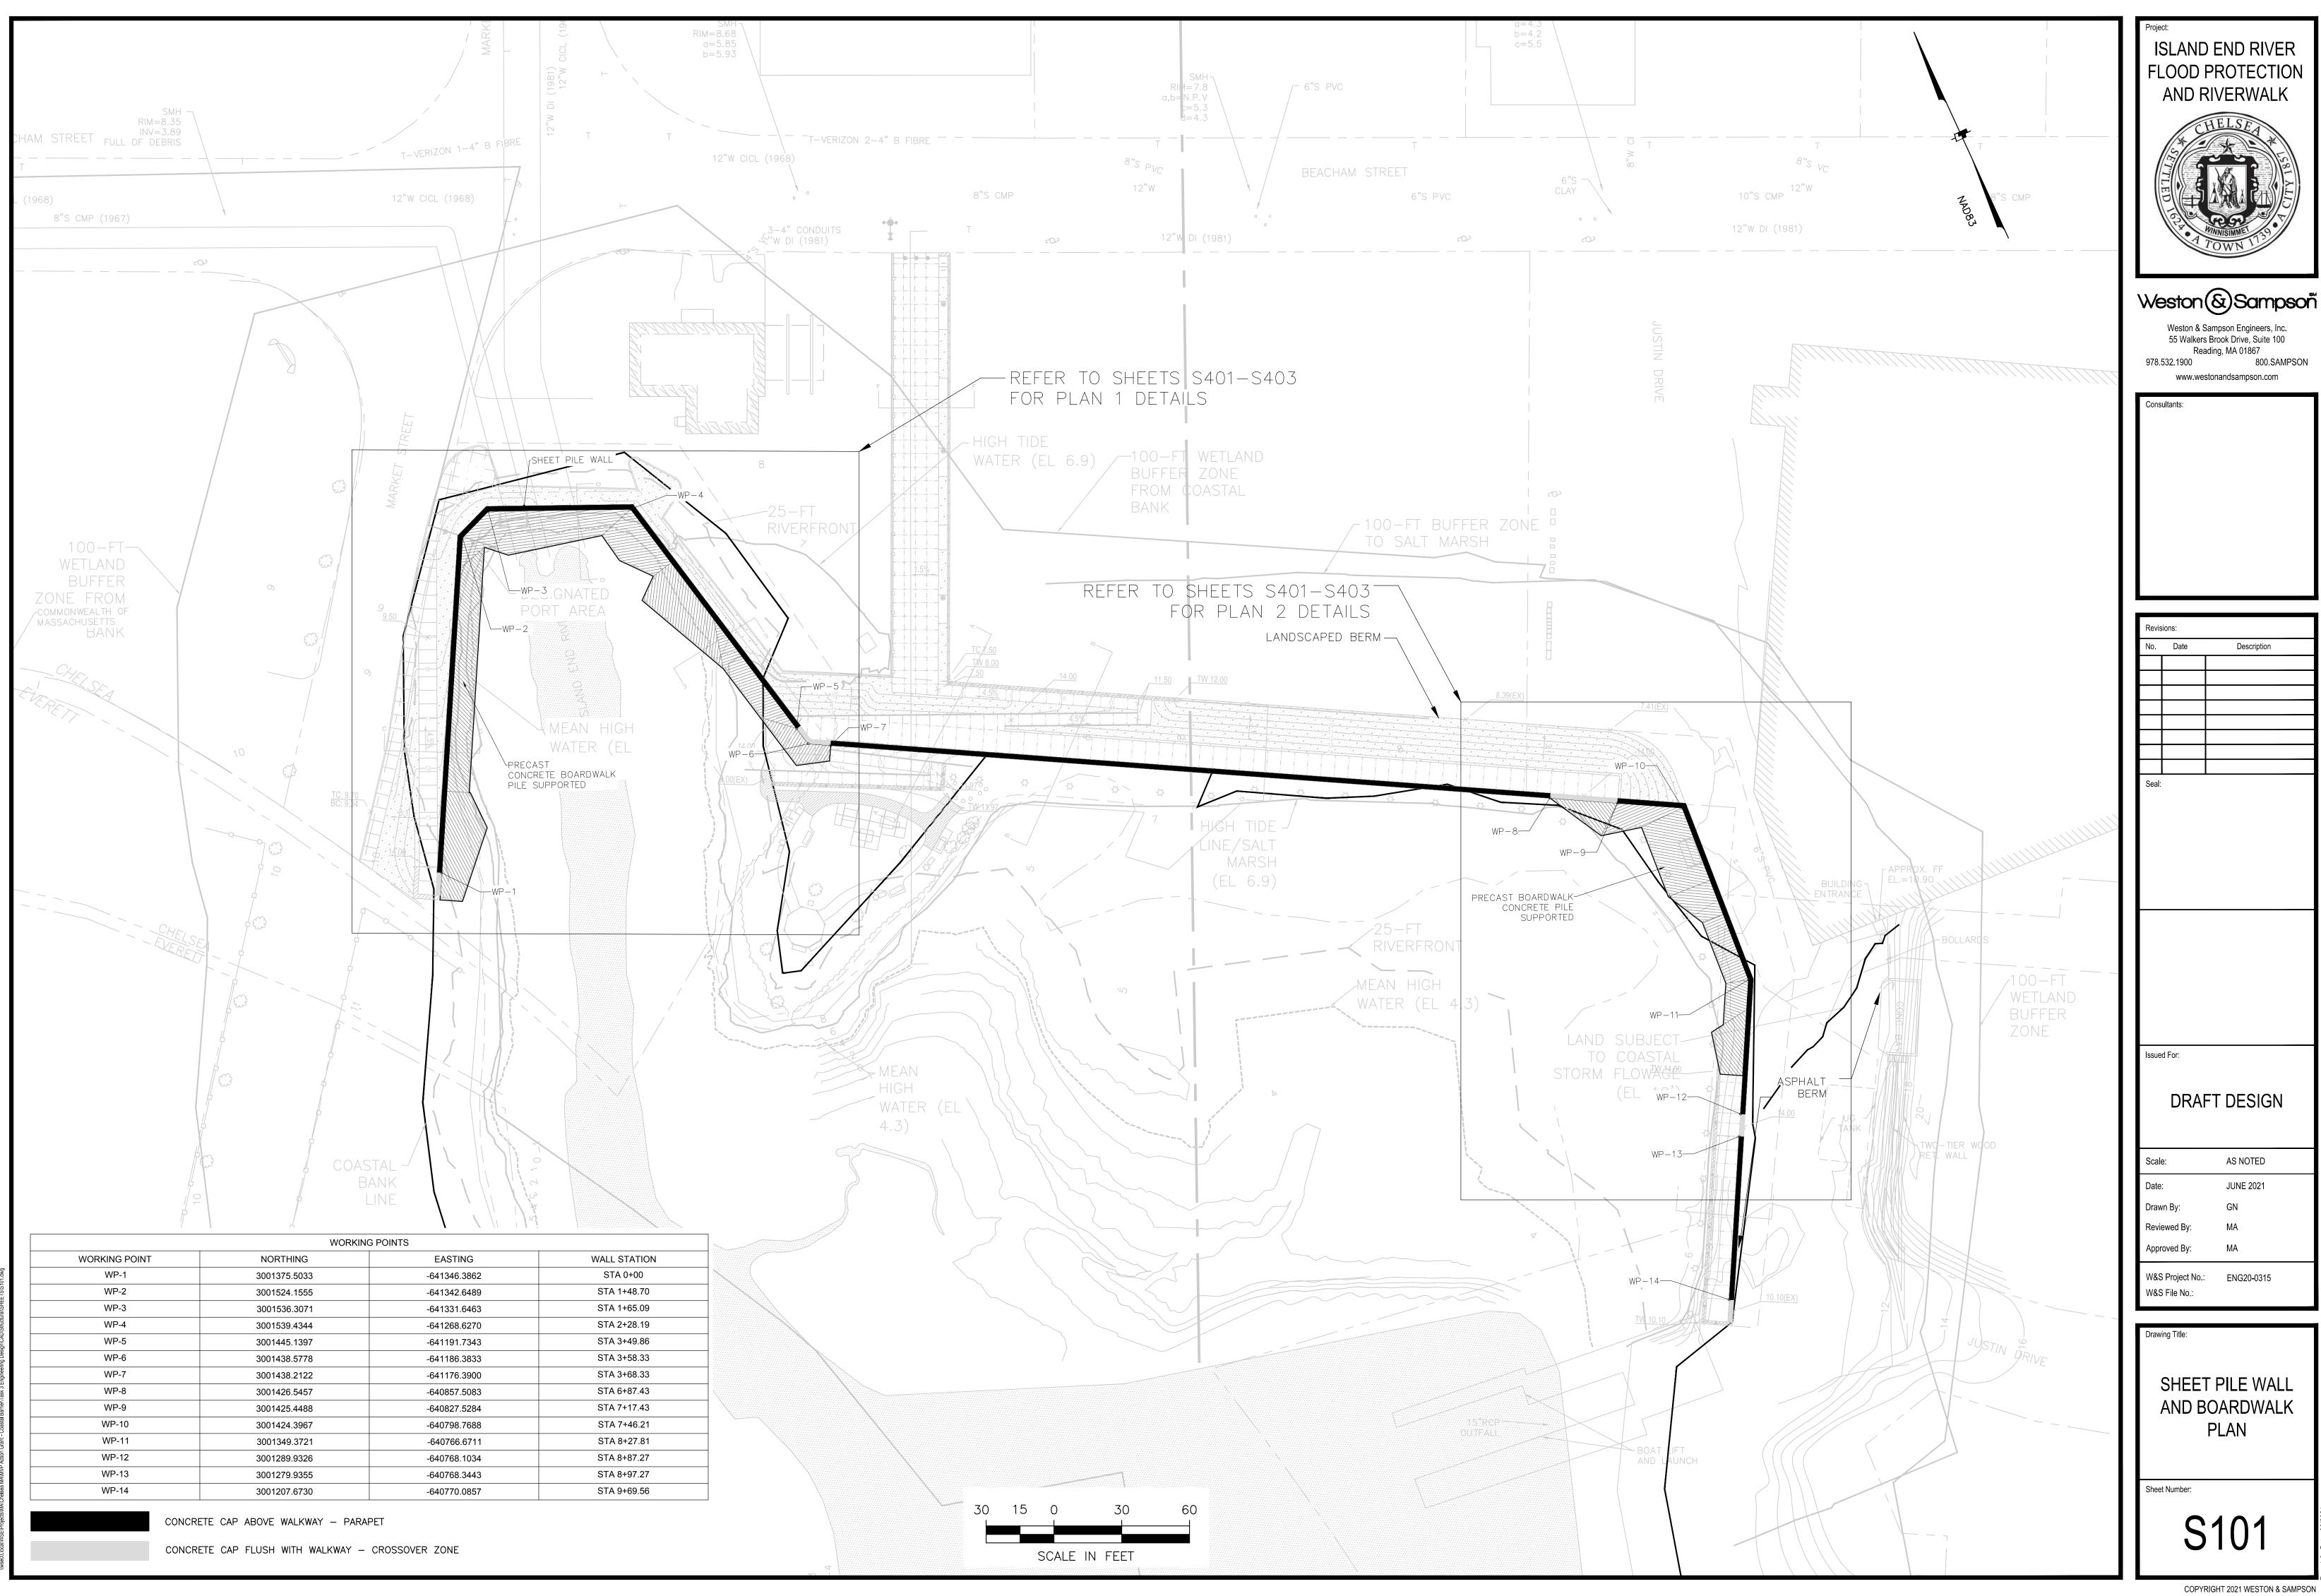
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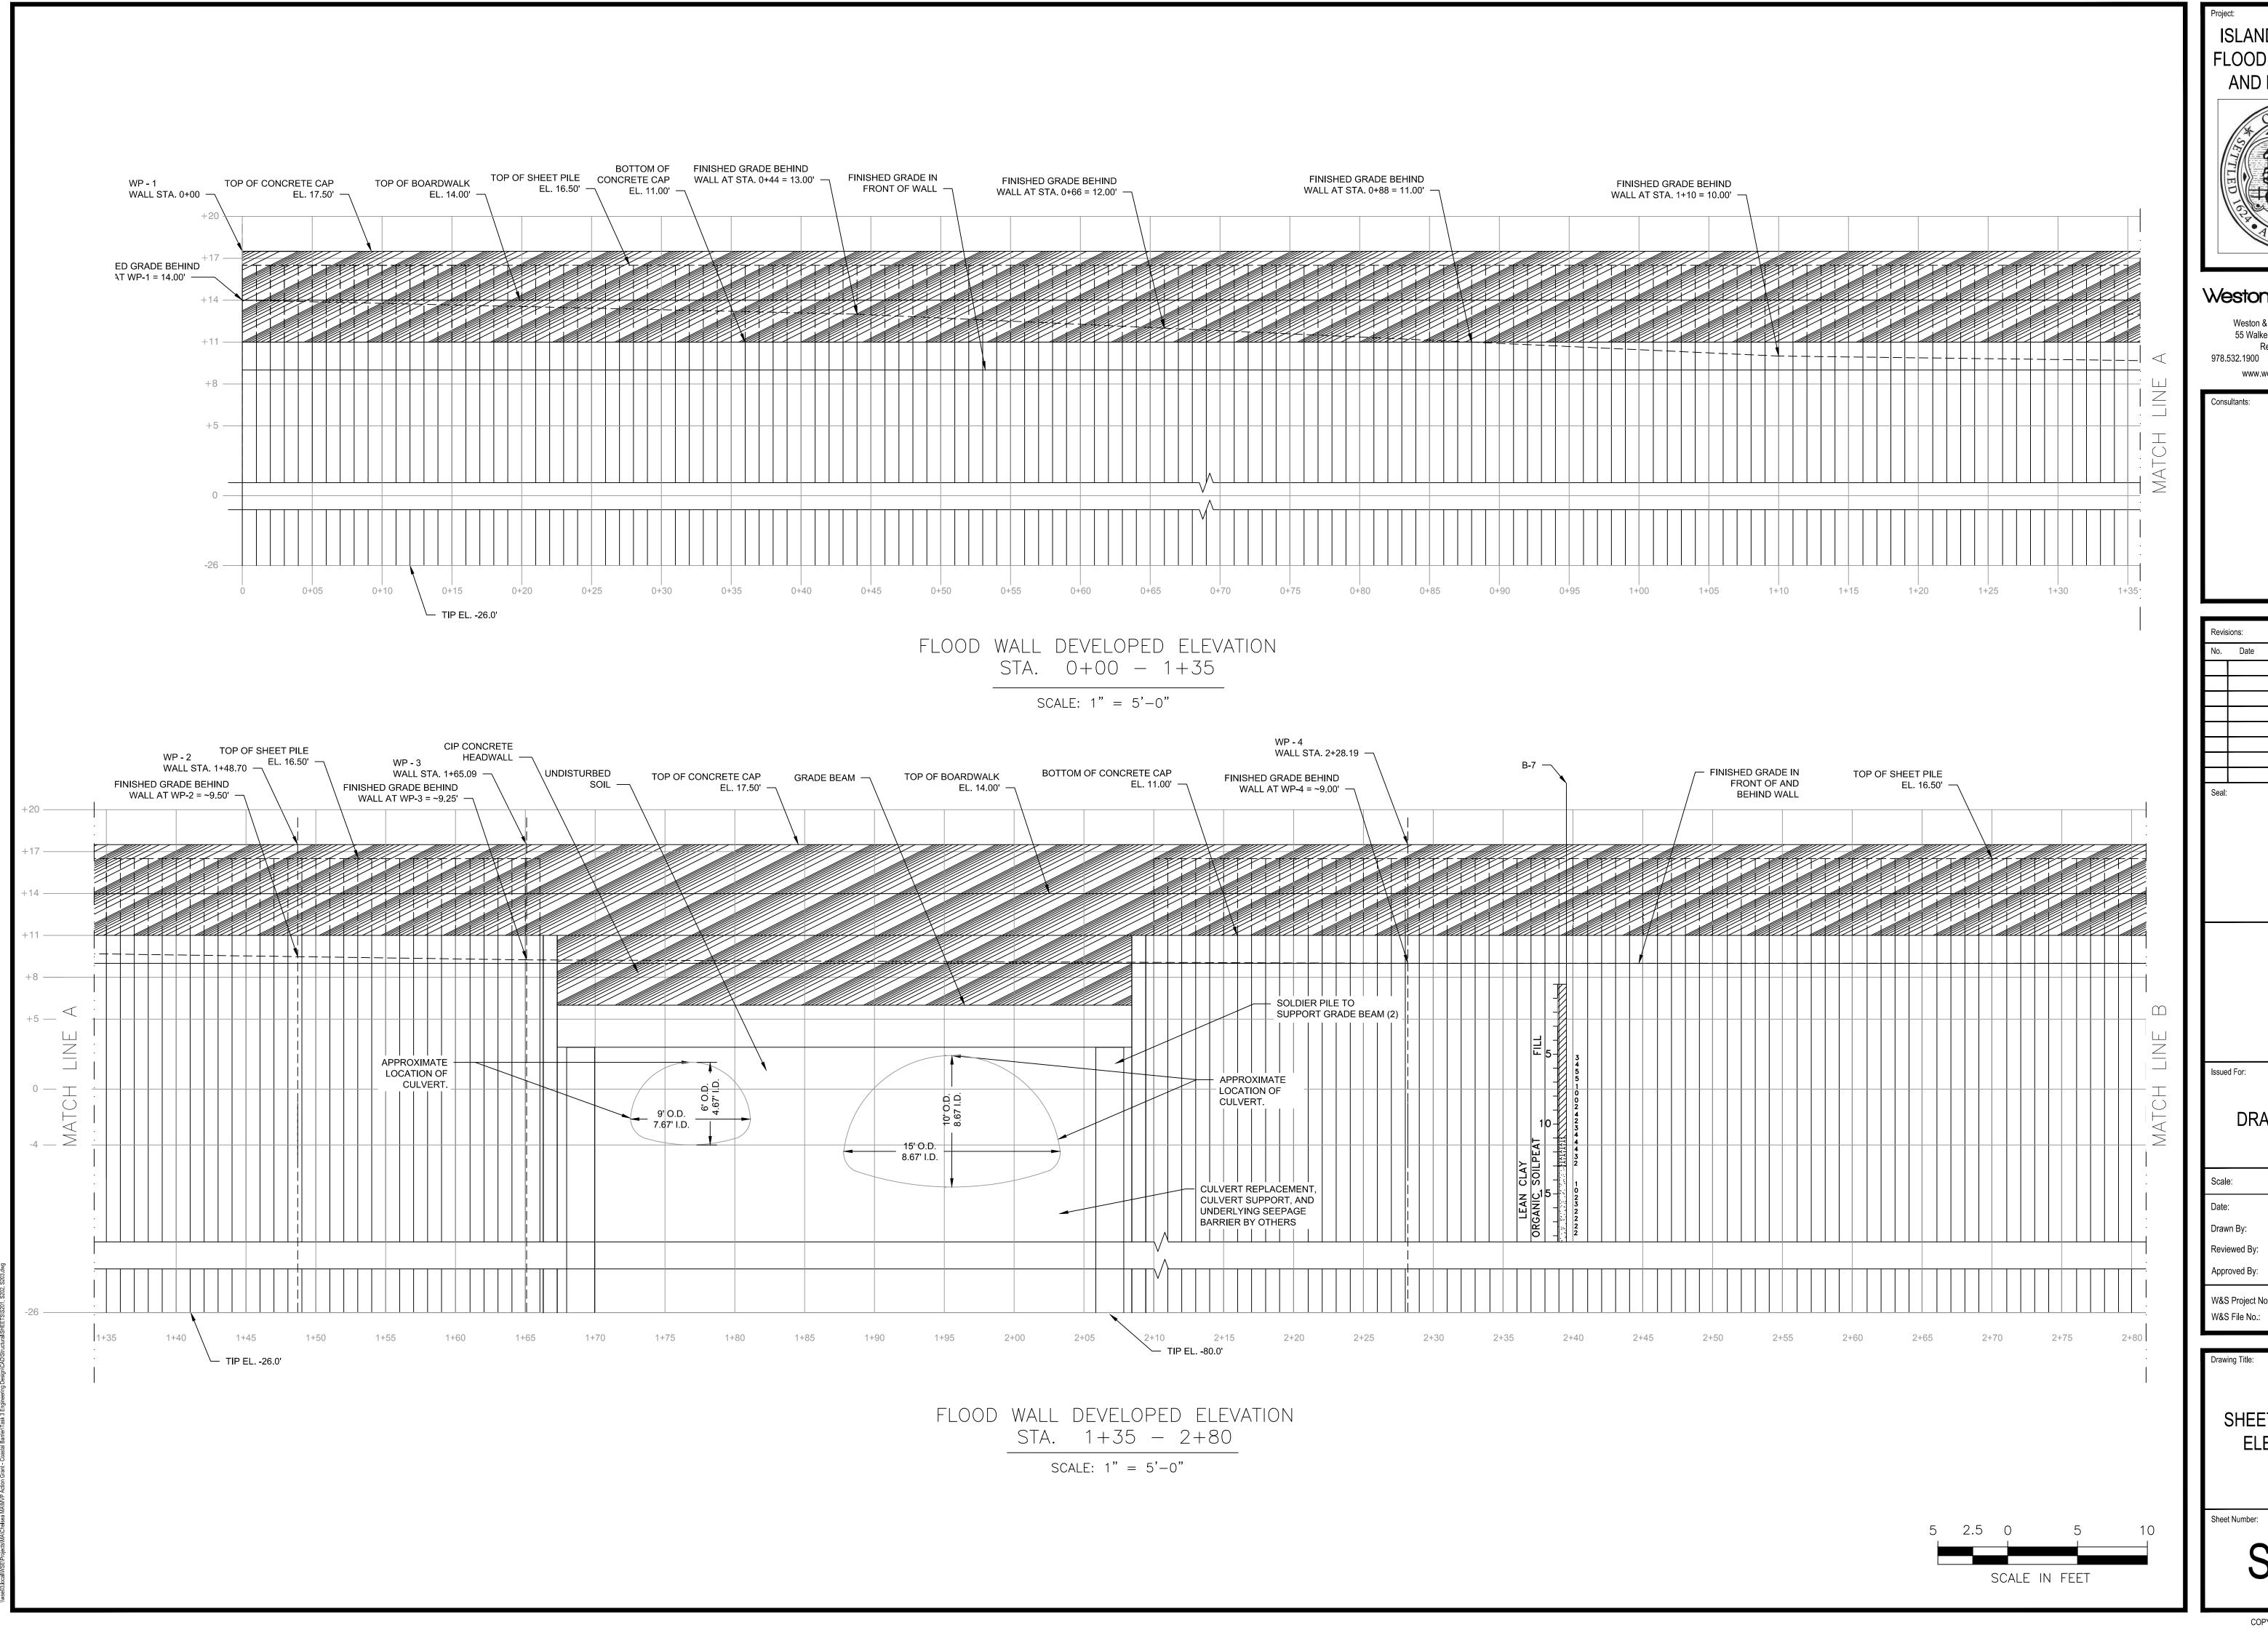
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SITE LIGHTING **DETAILS** 

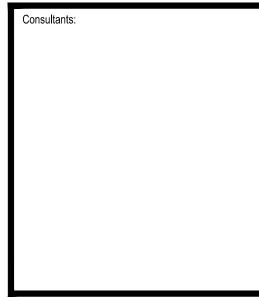
Sheet Number:

E501





FLOOD PROTECTION AND RIVERWALK

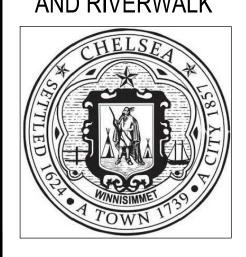

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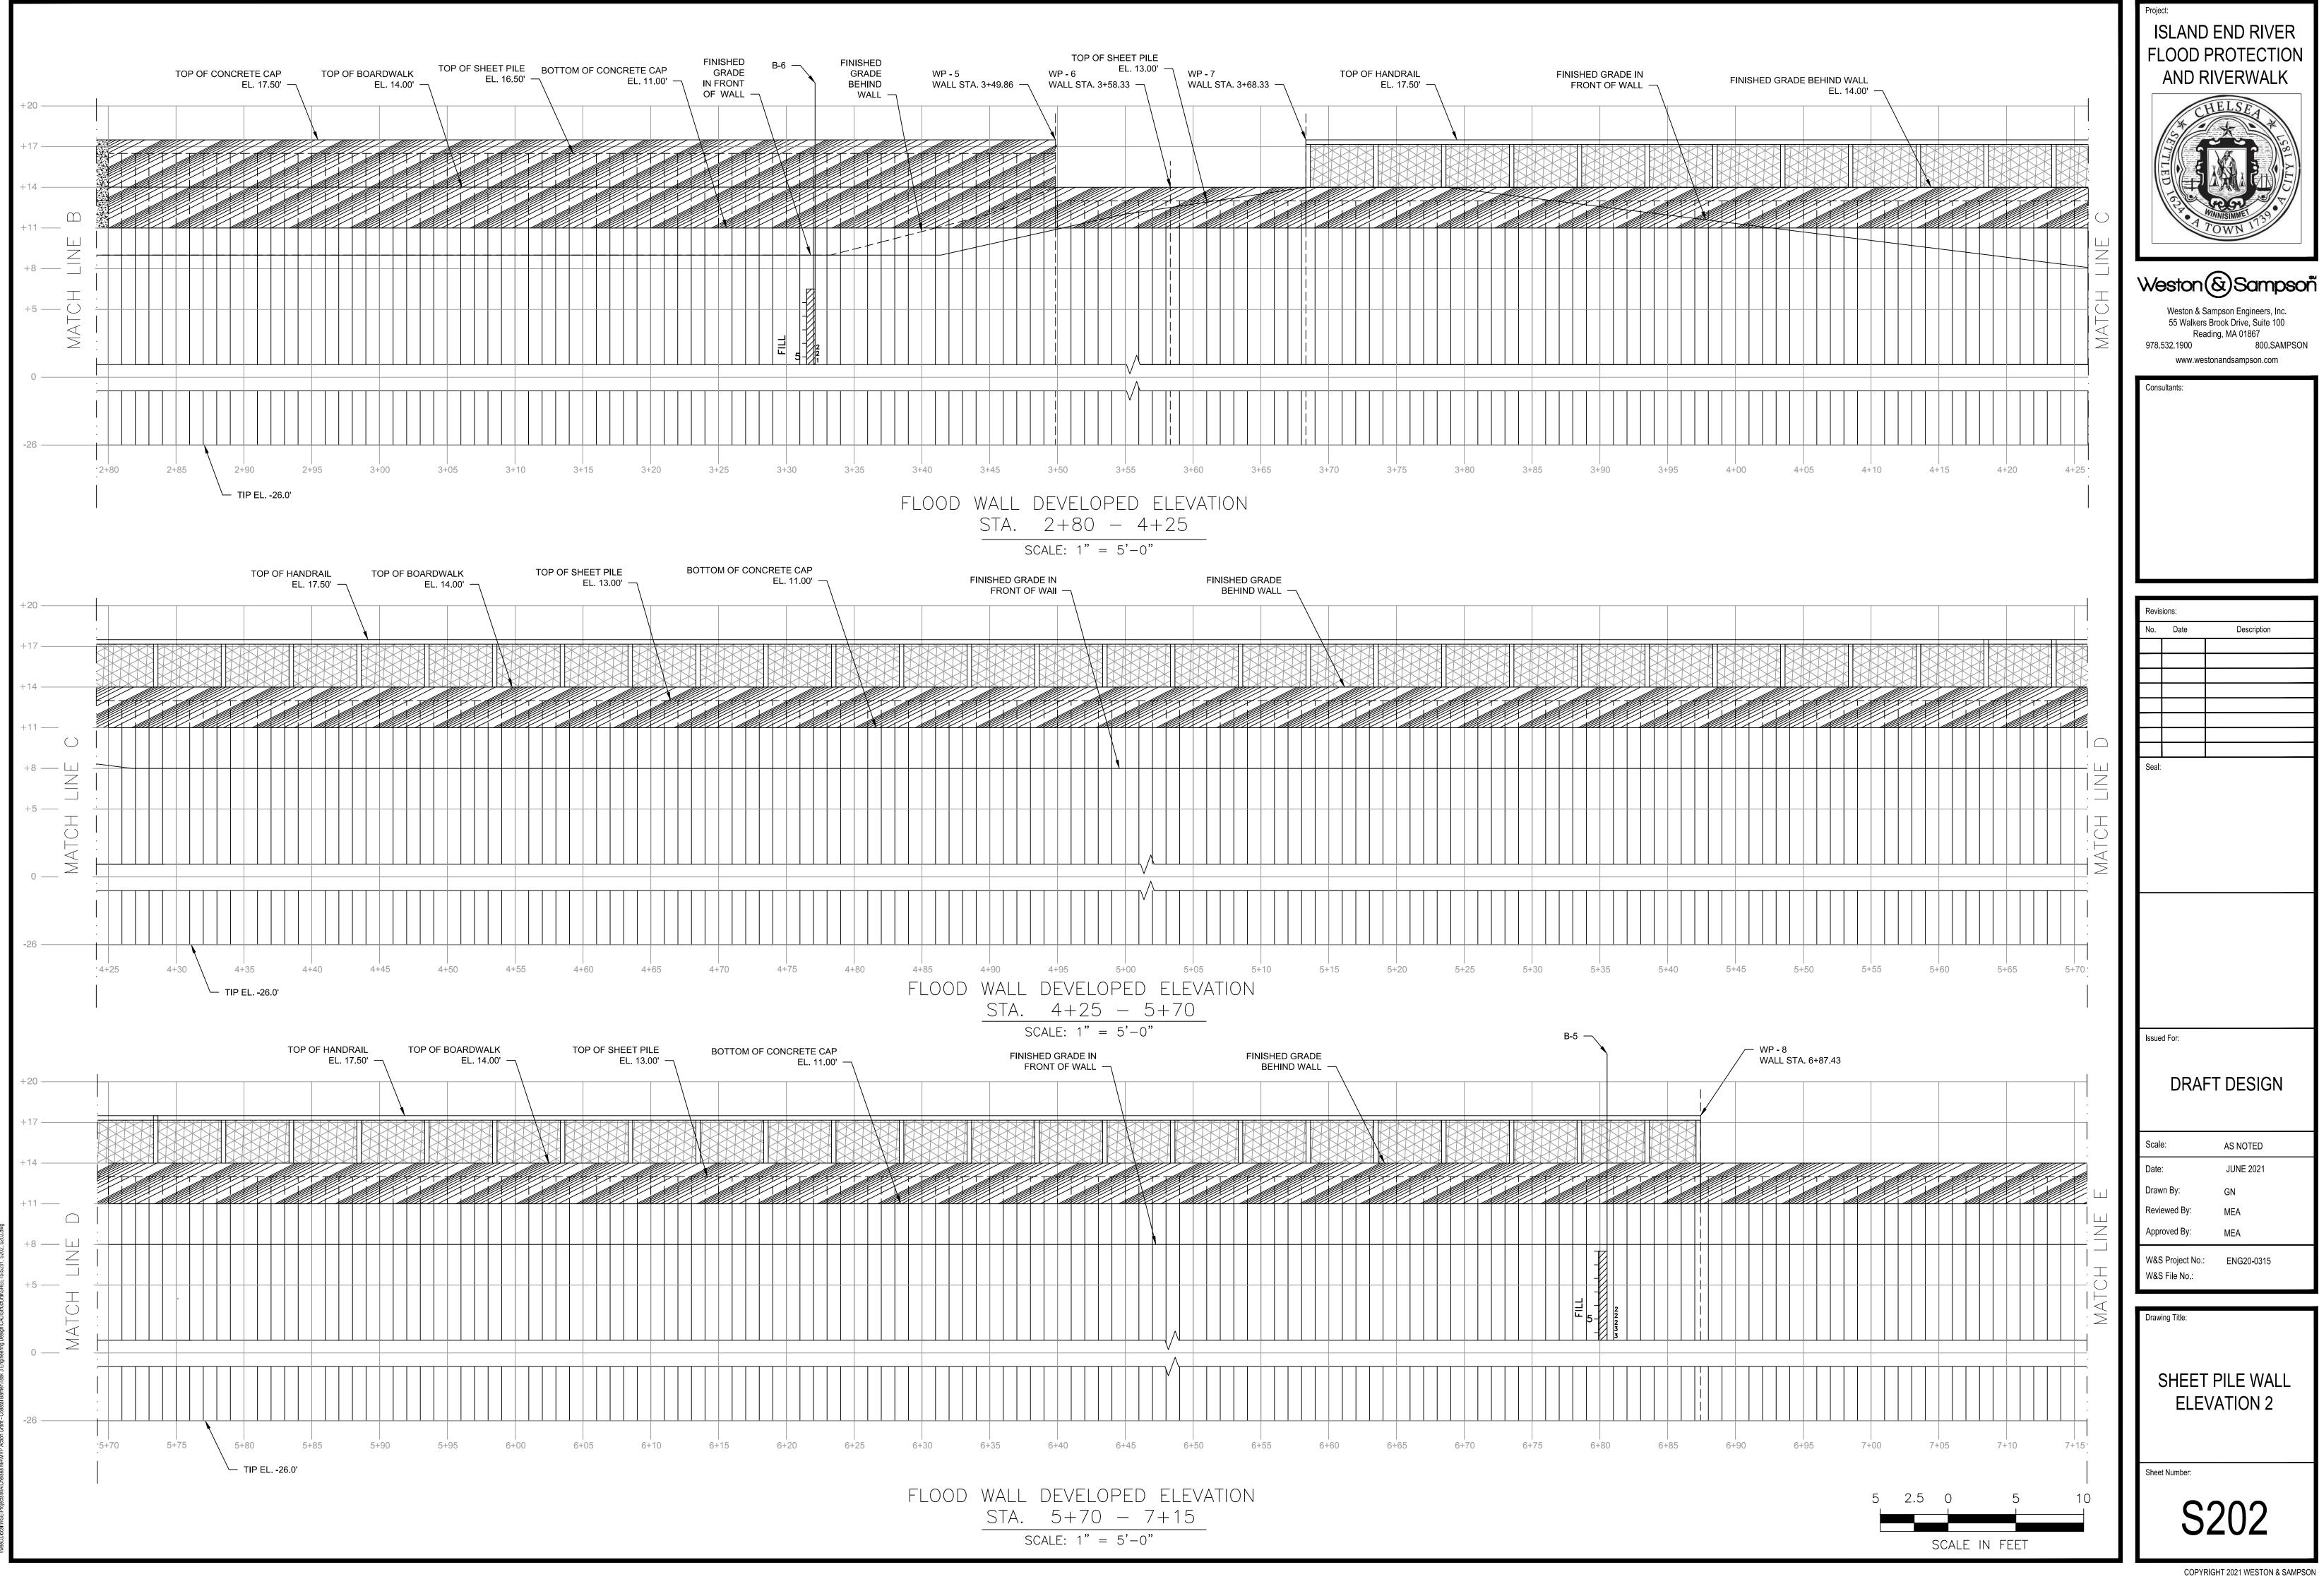
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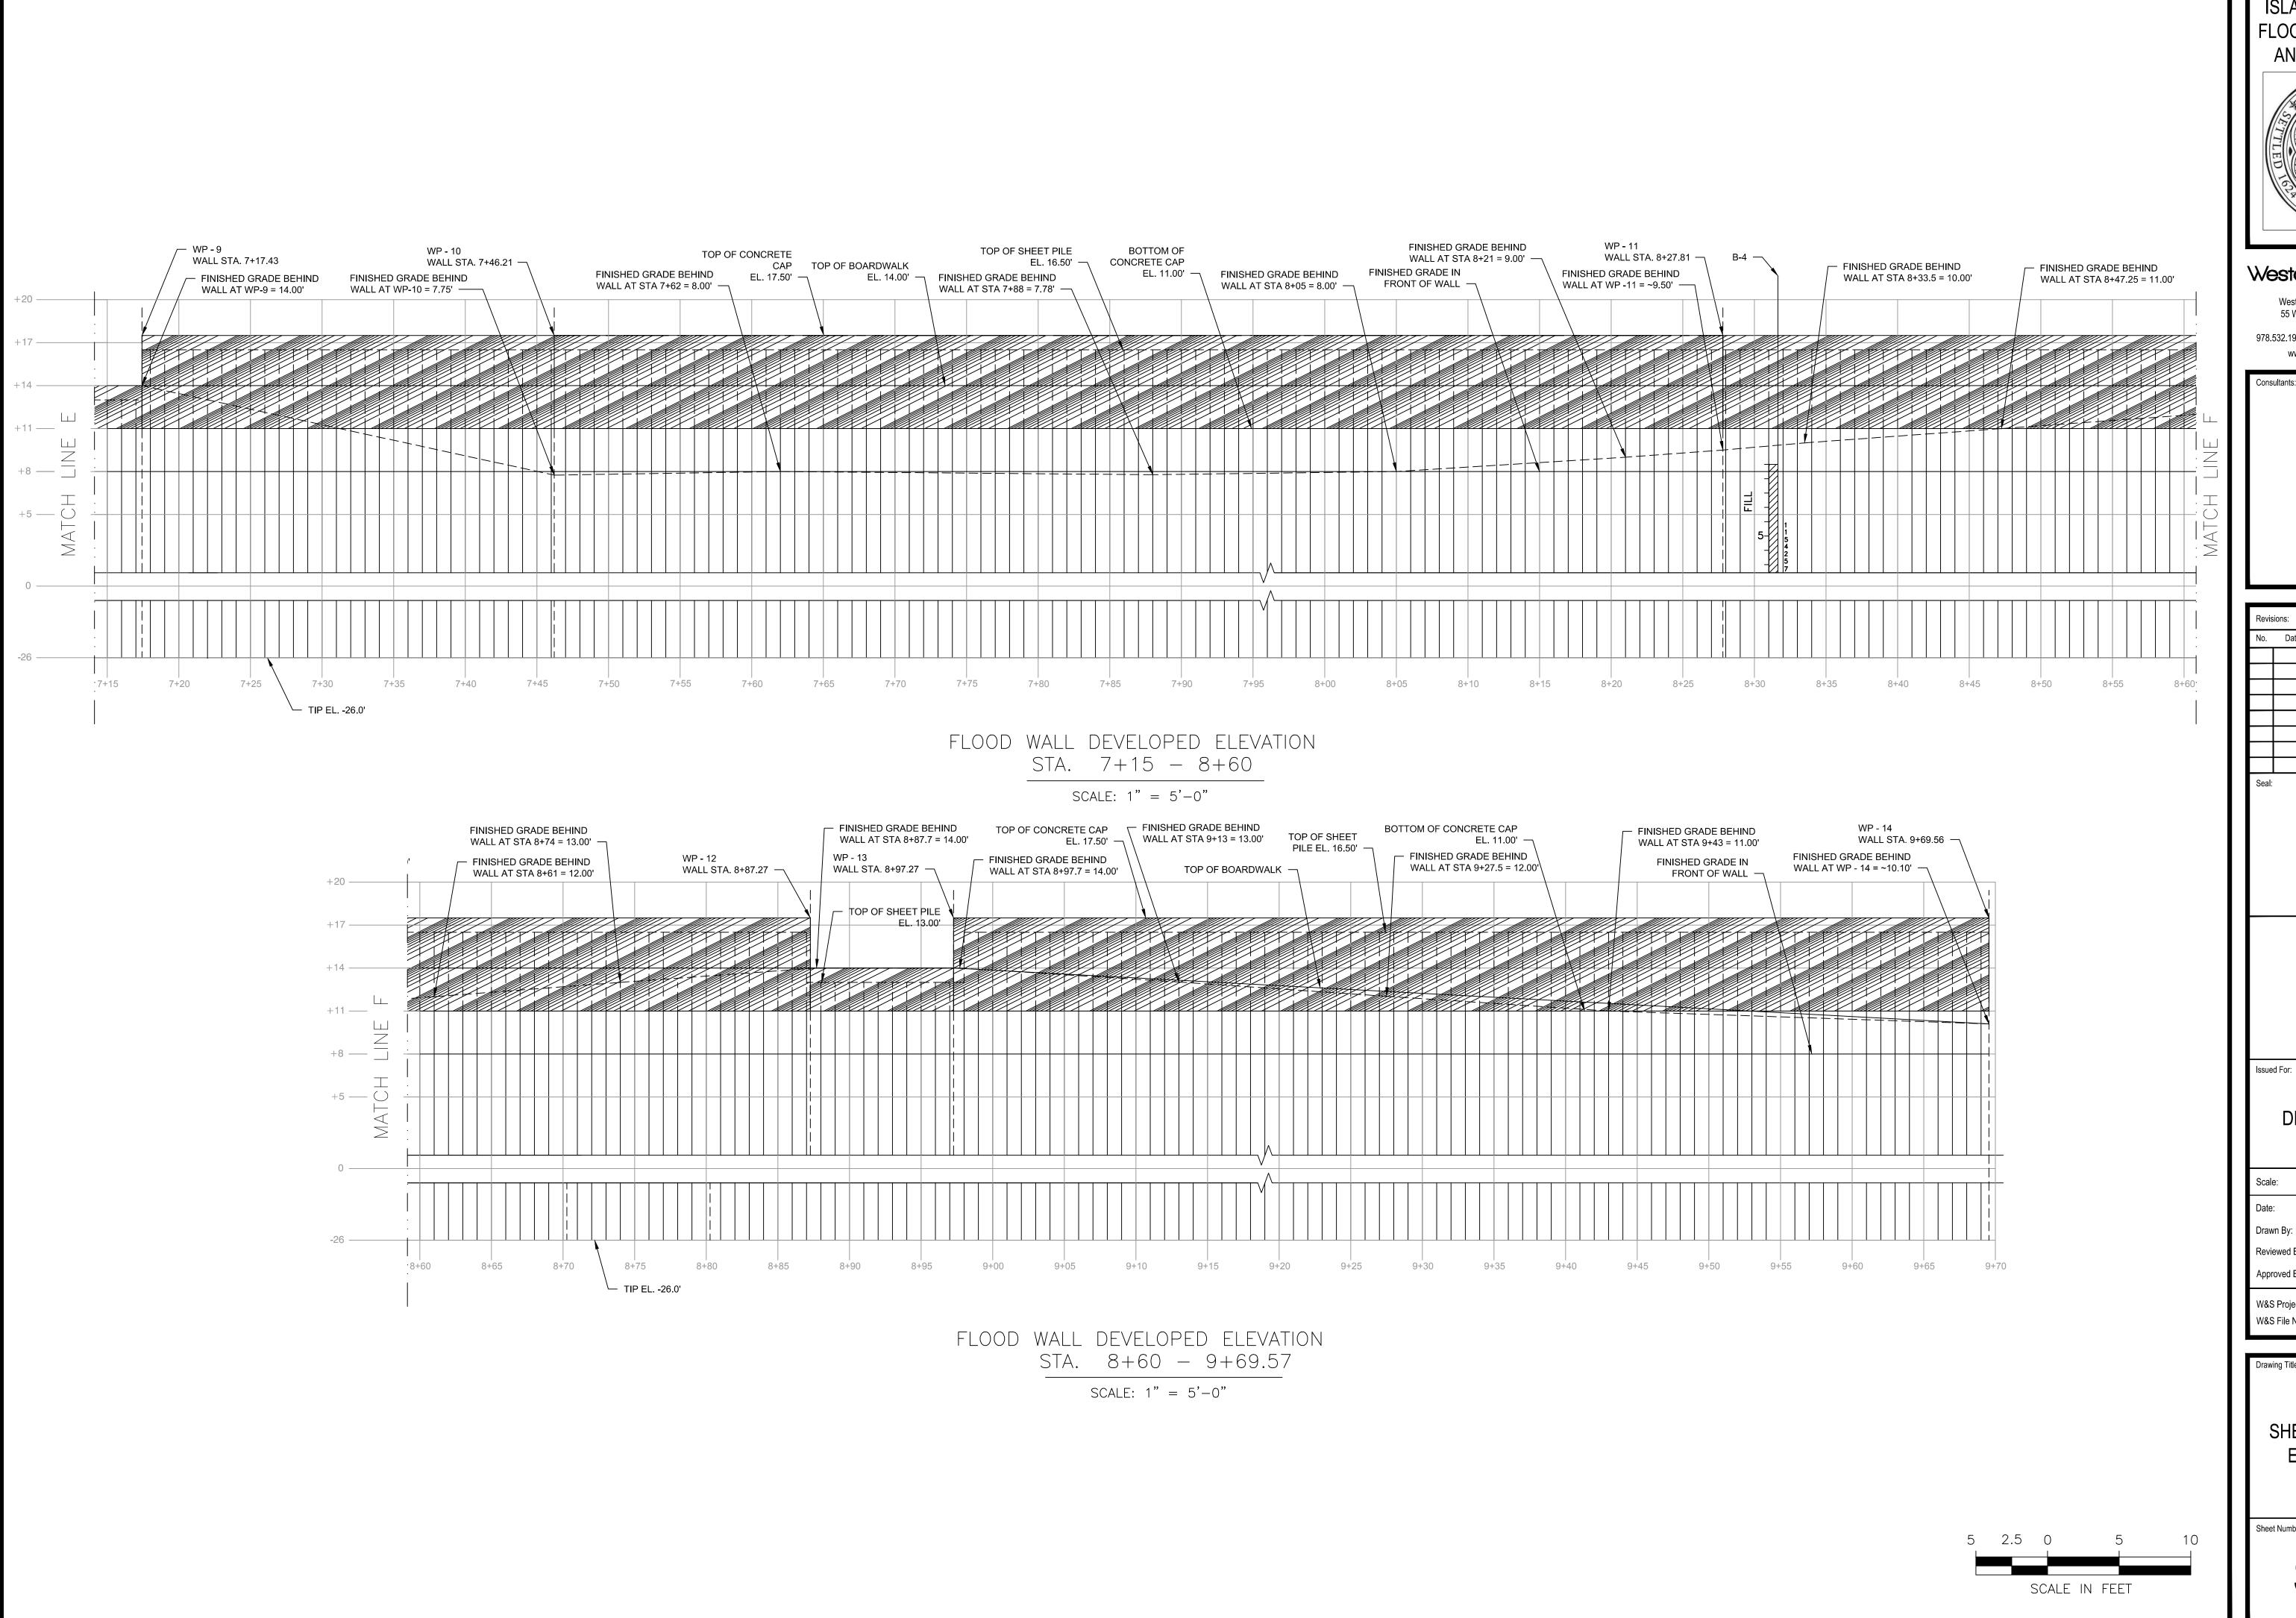
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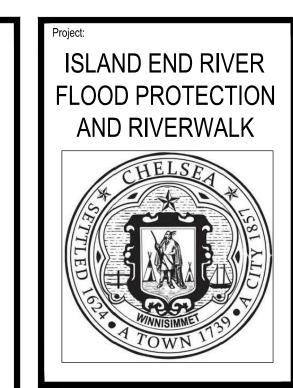
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Date:	JUNE 2021
Drawn By:	GN
Reviewed By:	MEA
Approved By:	MEA
W&S Project No.:	ENG20-0315

SHEET PILE WALL **ELEVATION 1** 



FLOOD PROTECTION





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Description

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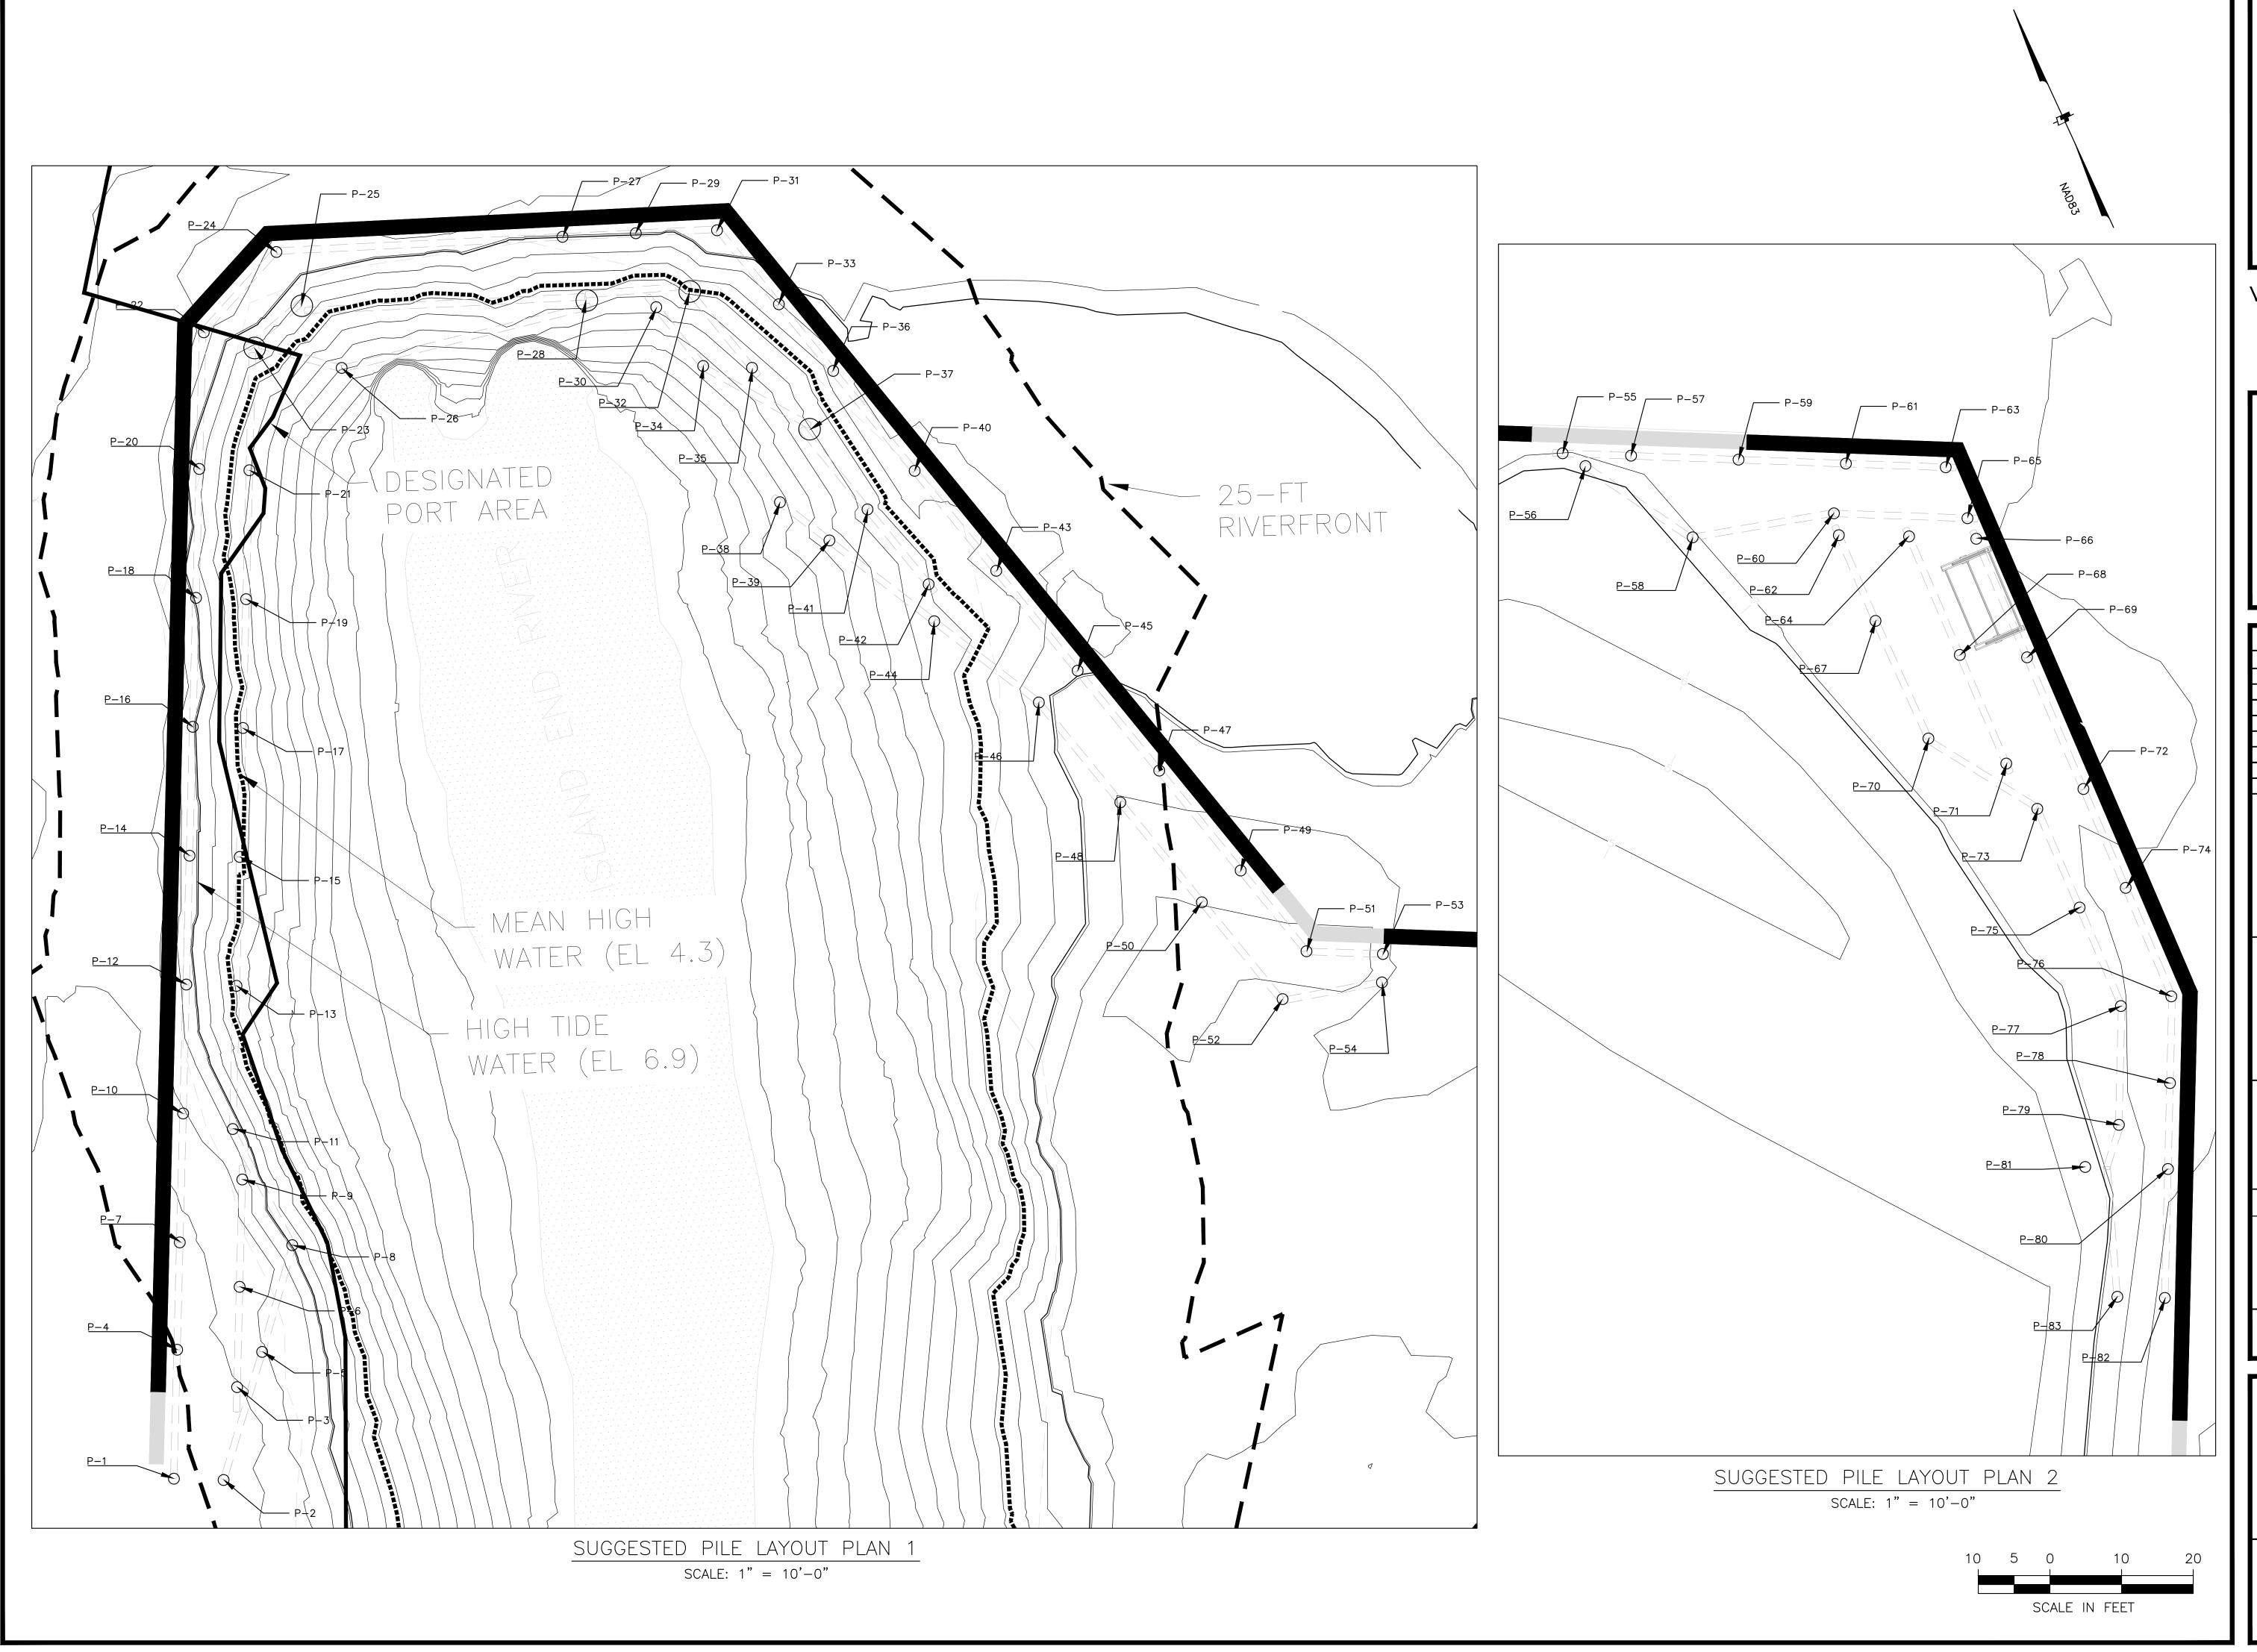
AS NOTED JUNE 2021 Approved By: W&S Project No.: ENG20-0315


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SHEET PILE WALL

**ELEVATION 3** 

Sheet Number:



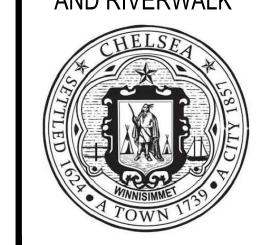

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W&S Project No.: ENG20-0315 PILE LAYOUT PLAN

AS NOTED


JUNE 2021

	PILE LAYOU	T WORKING POI	INTS PLAN 1	
PILE NO.	NORTHING	EASTING	PILE DIAMETER	* TOP OF PILE E
P1	3001363.4694	-641345.1882	18"	
P2	3001363.2948	-641338.2458	18"	
P3	3001376.2516	-641336.3642	18"	
P4	3001381.4637	-641344.7358	18"	
P5	3001381.1651	-641332.8609	18"	
P6	3001390.2472	-641336.0123	18"	
P7	3001396.4589	-641344.3589	18"	
 	3001396.0645	-641328.6700	18"	
 	3001405.2425	-641335.6353	18"	
P10	3001414.4532	-641343.9065	18"	
P11	3001414.4332	-641336.9589		
			18"	
P12	3001432.4476	-641343.4541	18"	
P13	3001432.2716	-641336.4563	18"	
P14	3001450.4419	-641343.0017	18"	
P15	3001450.2659	-641336.0039	18"	
P16	3001468.4362	-641342.5493	18"	
P17	3001468.2603	-641335.5515	18"	
P18	3001486.4305	-641342.0969	18"	
P19	3001486.2546	-641335.0991	18"	
P20	3001504.4248	-641341.6445	18"	
P21	3001504.2489	-641334.6467	18"	
P22	3001523.5031	-641341.0178	18"	
P23	3001521.3220	-641333.9150	36"	
P24	3001534.7064	-641330.8883	18"	
P25	3001537.7007	-641327.3351	36"	
P26	3001527.2097	-641321.7689		
			18"	
P27	3001536.8250	-641290.9445	18"	
P28	3001527.9441	-641287.5440	36"	
P29	3001537.3327	-641280.7132	18"	
P30	3001527.0064	-641277.8693	18"	
P31	3001537.7475	-641269.3774	18"	
P32	3001529.1960	-641273.1815	36"	
P33	3001527.4116	-641260.7585	18"	
P34	3001518.8025	-641271.3160	18"	
P35	3001518.5524	-641264.5021	18"	
P36	3001518.1117	-641253.1749	18"	
P37	3001509.9837	-641256.4675	36"	
P38	3001499.7796	-641260.5998	18"	
P39	3001494.4549	-641253.7031	18"	
P40	3001504.1618	-641241.7994	18"	
 P41	3001498.7901	-641248.3869	18"	
P42	3001488.3277	-641239.8553	18"	
P43	3001400.3277	-641239.0333 $-641230.4240$		
			18"	
P44	3001483.1593	-641239.0727	18"	
P45	3001476.2620	-641219.0485	18"	
P46	3001471.8383	-641224.4735	18"	
P47	3001462.3122	-641207.6731	18"	
P48	3001457.8884	-641213.0980	18"	
P49	3001448.3623	-641196.2976	18"	
P50	3001443.9385	-641201.7226	18"	
P51	3001437.1036	-641187.1167	18"	
P52	3001430.4109	-641190.4463	18"	
P53	3001436.7132	-641176.4449	18"	
P54	3001432.7533	-641176.5897	18"	

PILE NO.	NORTHING	EASTING	PILE DIAMETER	* TOP OF PILE
P55	3001424.8876	-640853.2160	18"	
P56	3001423.0946	-640850.0430	18"	
P57	3001424.5384	-640843.6708	18"	
P58	3001413.1415	-640835.0817	18"	
P59	3001423.9900	-640828.6808	18"	
P60	3001416.4982	-640815.3654	18"	
P61	3001423.4416	-640813.6908	18"	
P62	3001413.4401	-640814.6763	18"	
P63	3001422.9324	-640799.7738	18"	
P64	3001413.2770	-640804.8882	18"	
P65	3001415.8164	-640796.7294	18"	
P66	3001412.9428	-640795.5000	18"	
P67	3001401.4880	-640809.5629	18"	
P68	3001396.7279	-640797.8080	18"	
P69	3001396.3938	-640788.4198	18"	
P70	3001385.4746	-640802.1818	18"	
P71	3001381.5580	-640791.3179	18"	
P72	3001378.0059	-640780.5530	18"	
P73	3001375.2525	-640786.9887	18"	
P74	3001364.2151	-640774.6528	18"	
P75	3001361.4617	-640781.0886	18"	
P76	3001349.0616	-640768.2850	18"	
P77	3001347.7079	-640775.3184	18"	
P78	3001336.9598	-640768.4706	18"	
P79	3001331.1302	-640775.6119	18"	
P80	3001324.9633	-640768.7597	18"	
P81	3001325.2415	-640780.3036	18"	
P82	3001306.9686	-640769.1933	18"	
P83	3001307.1283	-640775.8237	18"	

\*NOTE: TOP OF PILE ELEVATION IS BASED ON THE ASSUMED DIMENSIONS SHOWN IN THE DETAILS. ANY VARIANCE FROM THE DIMENSIONS SHOWN ON THESE PLANS WILL REQUIRE THE CONTRACTOR TO RECALCULATE THE TOP OF PILE ELEVATIONS TO ACCOMMODATE HIS PROPOSED BOARDWALK STRUCTURE.

ISLAND END RIVER FLOOD PROTECTION AND RIVERWALK

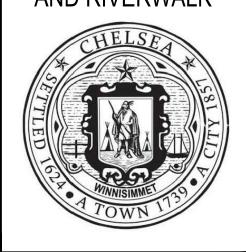

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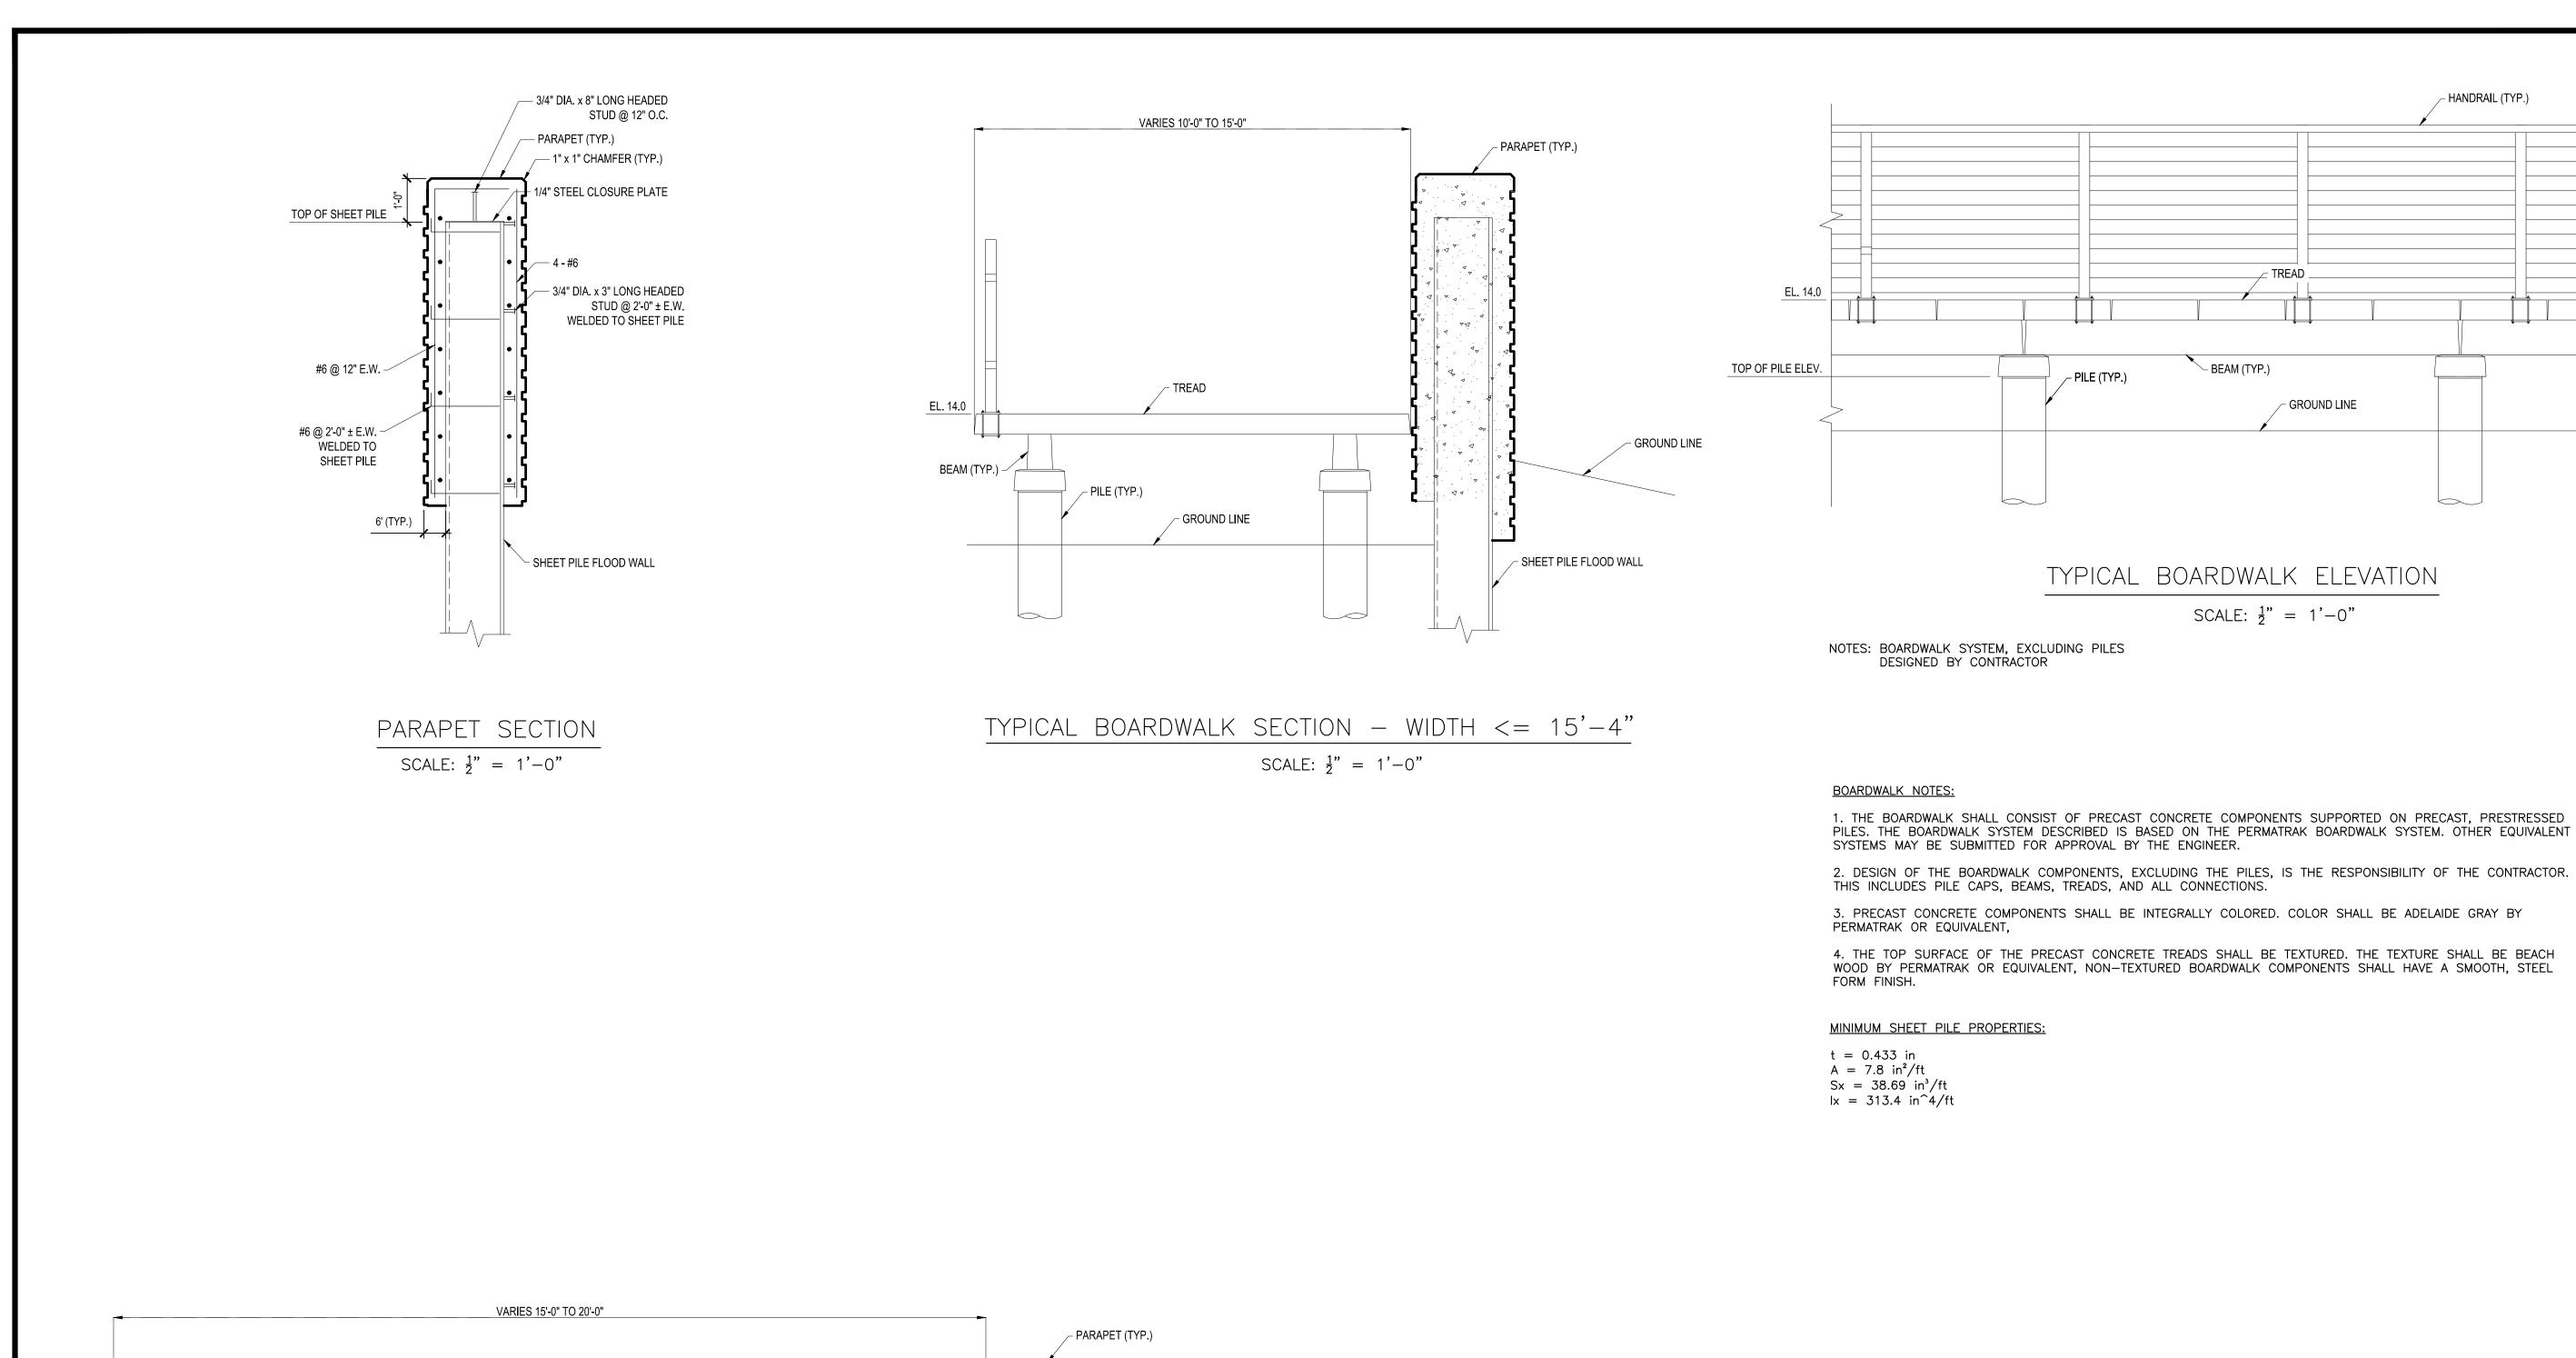
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PILE LAYOUT WORKING POINTS

Sheet Number:



GROUND LINE

✓ SHEET PILE FLOOD WALL


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BEAM (TYP.) ~

- GROUND LINE

TYPICAL BOARDWALK SECTION - WIDTH <= 15'-0"

SCALE:  $\frac{1}{2}$ " = 1'-0"

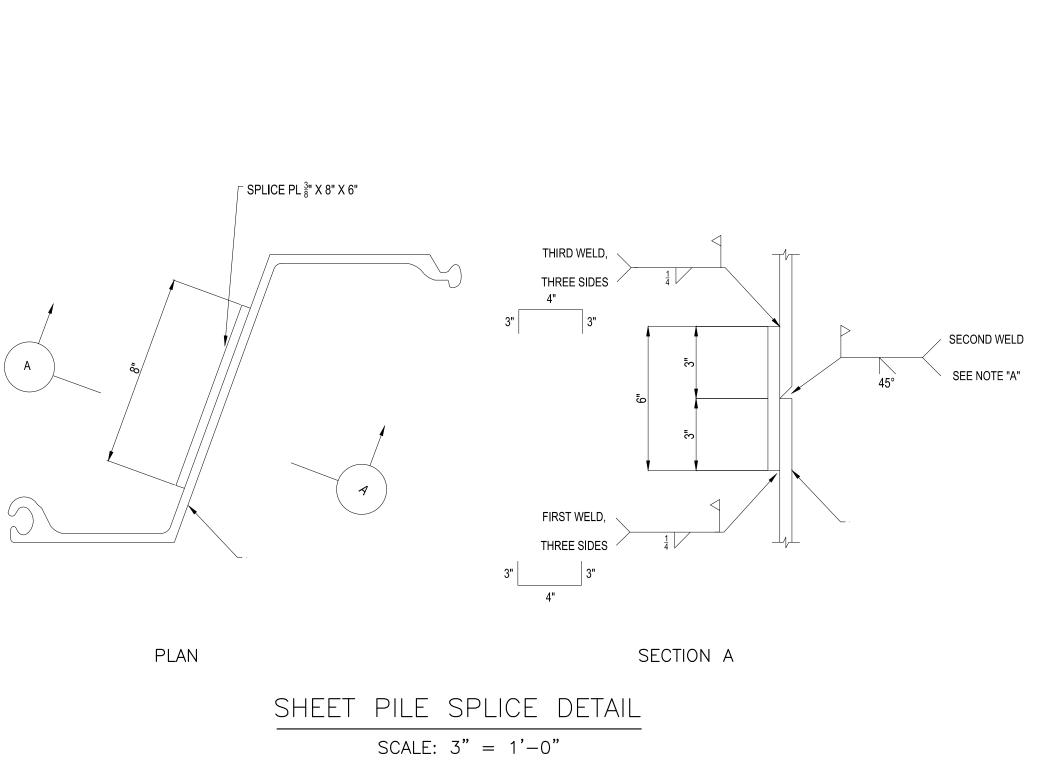

NOTE "A": GROOVE WELD SHALL EXTEND THE FULL LENGTH OF THE SHEET PILE WEB AND FLANGES EXCLUDING THE INTERLOCKS.

ISLAND END RIVER FLOOD PROTECTION AND RIVERWALK

- HANDRAIL (TYP.)

\_ TREAD .

✓ GROUND LINE

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Description

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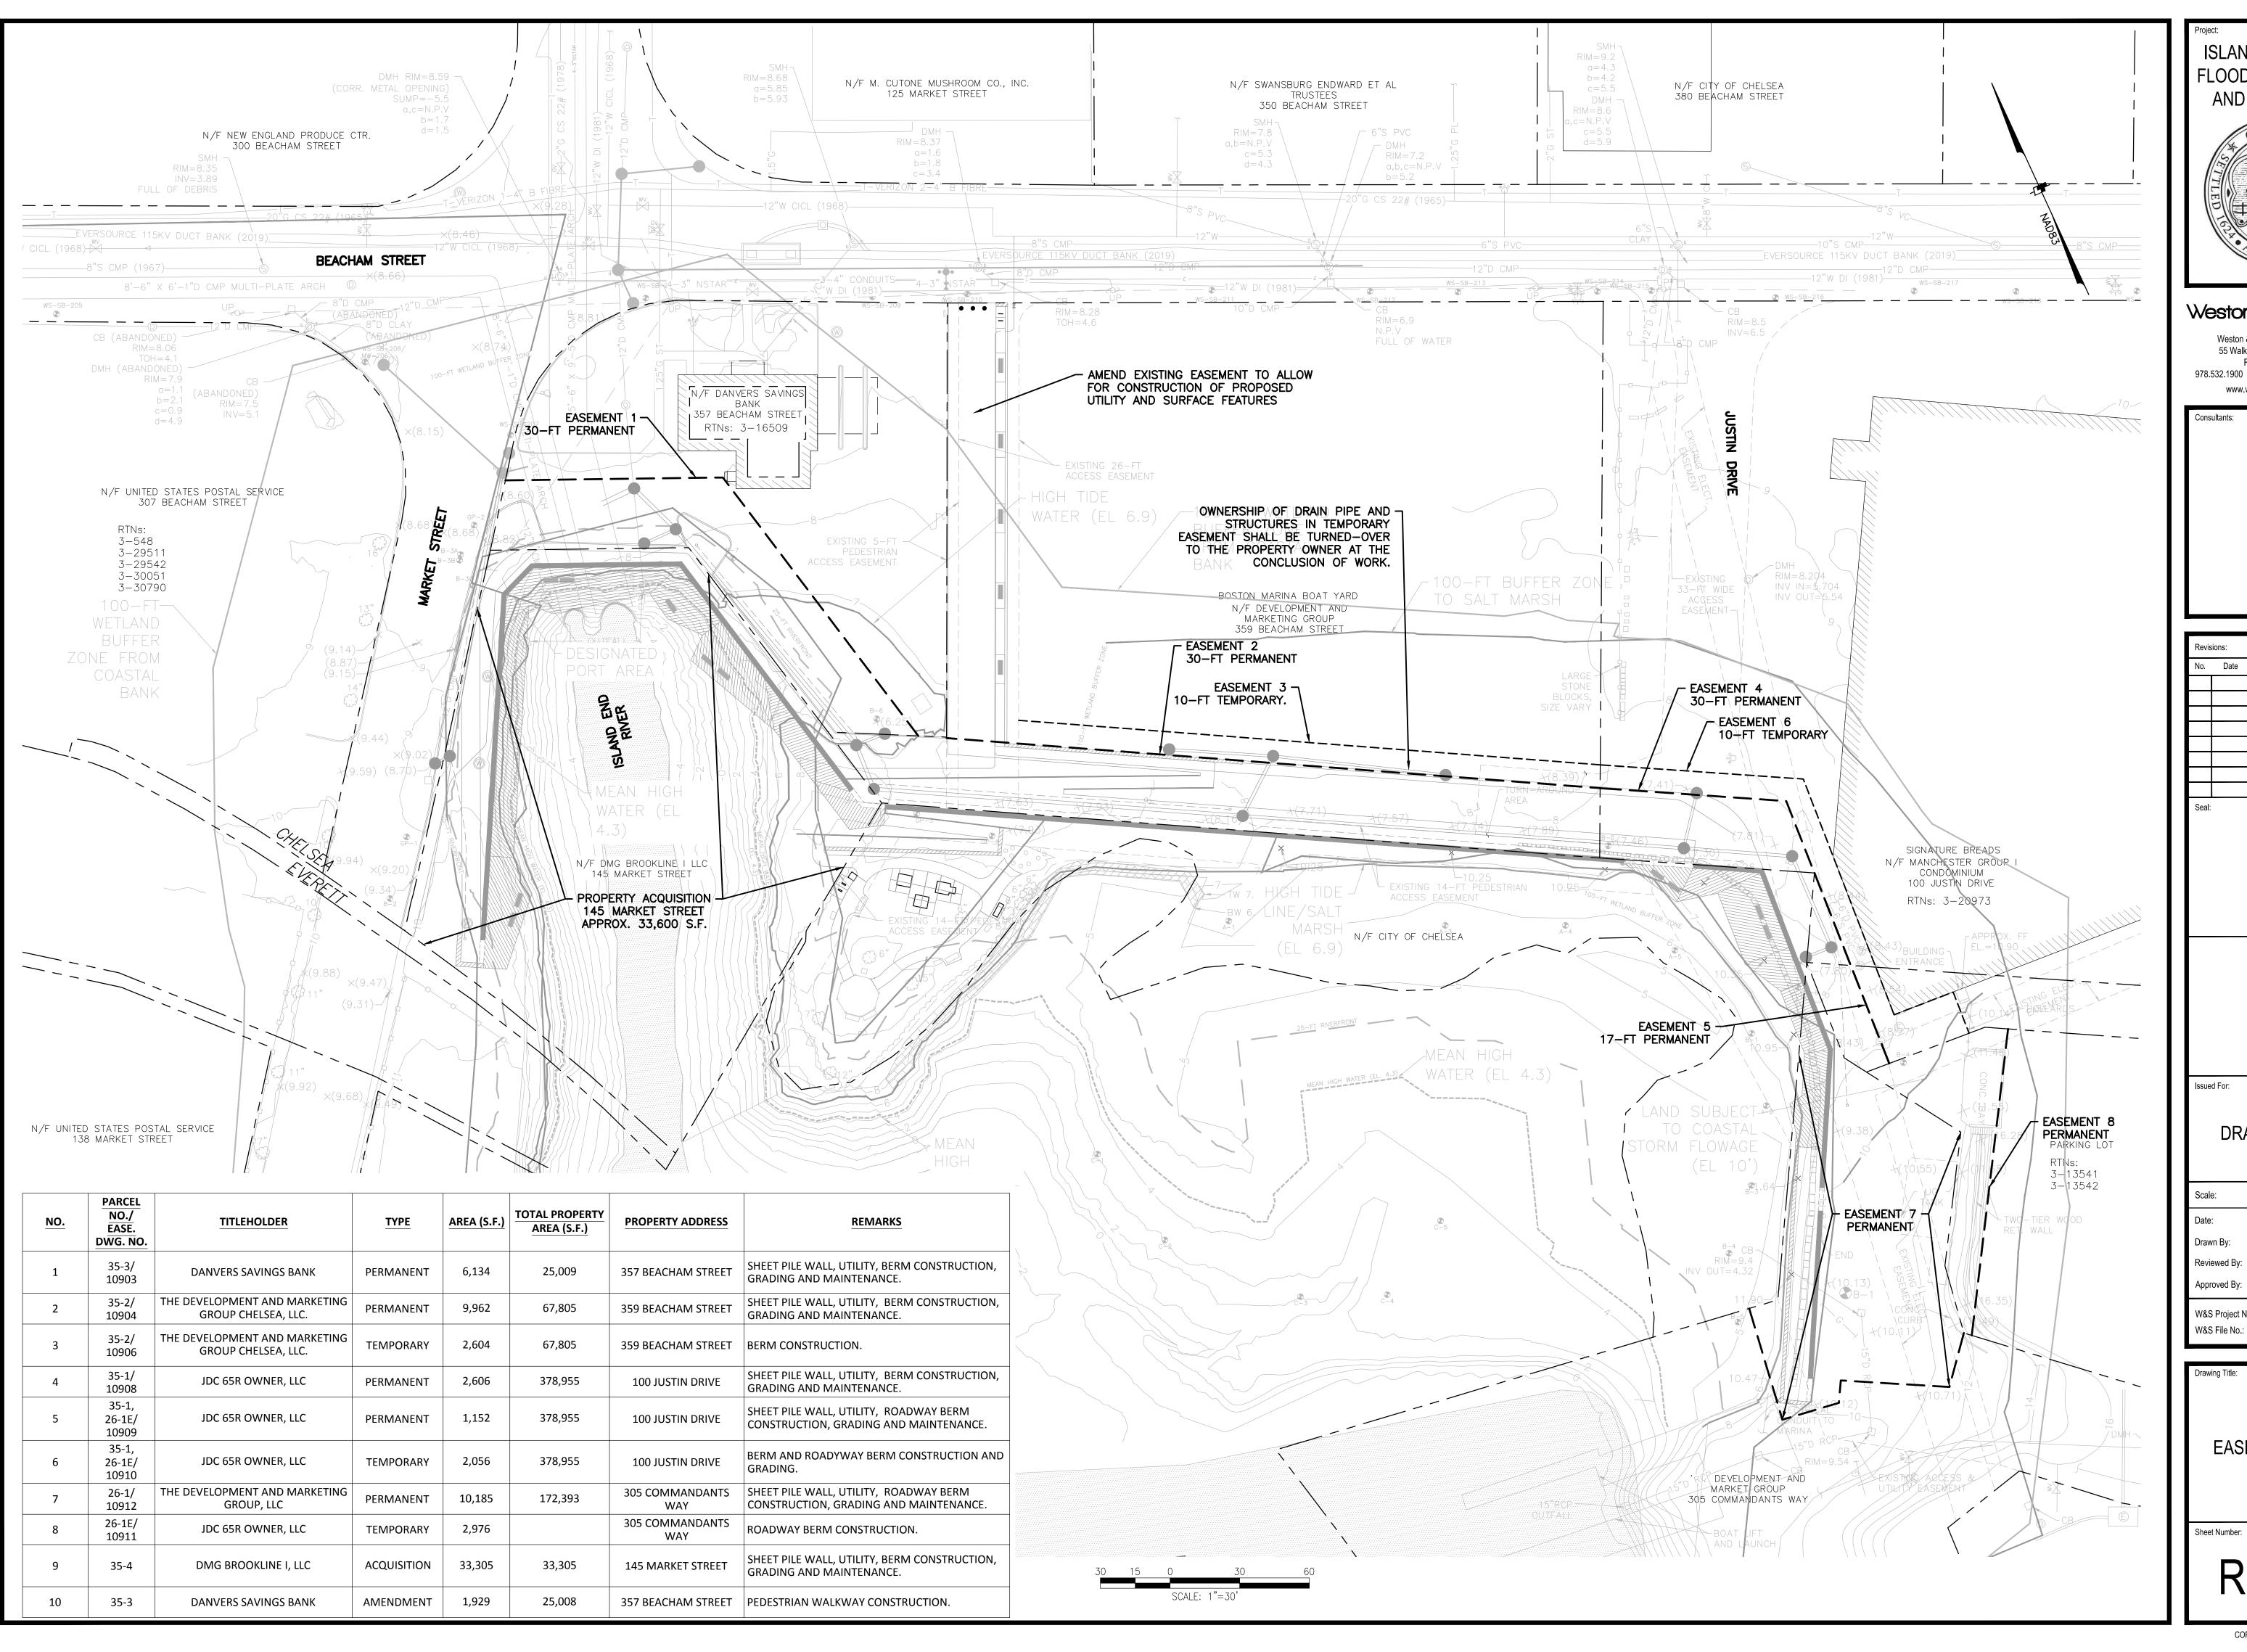
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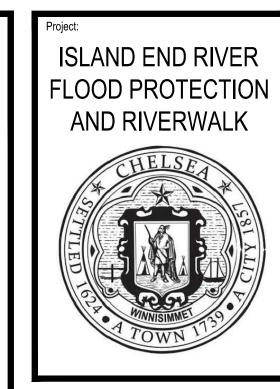
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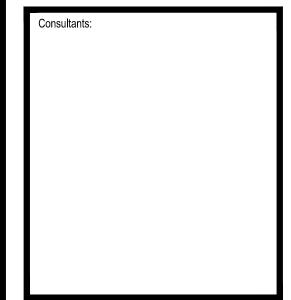
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Reviewed By:	MEA
Approved By:	MEA
W&S Project No.:	ENG20-0315

PILE DETAILS





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EASEMENT PLAN

Sheet Number: